## Drawing Register

No.	Title	Rev
TP00.00	Cover Sheet	А
TP00.01	Site Plan	-
TP00.02	Staging Plan	-
TP00.03	Demolition / Existing / Construction Management Plan	-
TP01.01	Ground	А
TP01.02	Ground Mezzanine	А
TP01.03	Level 1	А
TP01.04	Level 1 Mezzanine	А
TP01.05	Level 2	А
TP01.06	Level 2 Mezzanine	А
TP01.07	Roof	А
TP01.10	Entry Driveway Plan	-
TP02.01	Elevations	А
TP02.02	Elevations	А
TP02.03	Elevations	-
TP02.04	Elevations	А
TP03.01	Site Sections 01	-
TP03.02	Site Sections 02	Α
TP03.03	Site Sections 03	-
TP03.04	Ramp Section	-
TP04.01	Shadows	Α
TP04.02	Shadows	А
TP04.03	Height Encroachment	А
TP04.04	Shadows	-
TP04.05	Shadows	-
TP04.06	Shadows	-
TP04.07	Shadows	-
TP05.01	Landscape Plan	A
TP05.02	GFA	A
TP05.03	Development Summary	A



# Taren Point Project 72-78 Box Road, Taren Point

4/04/2022 11:58:18 AM

Plans - PPSSSH-104 (17 May 2022) - DA21/1131

## Landmark Group

Client

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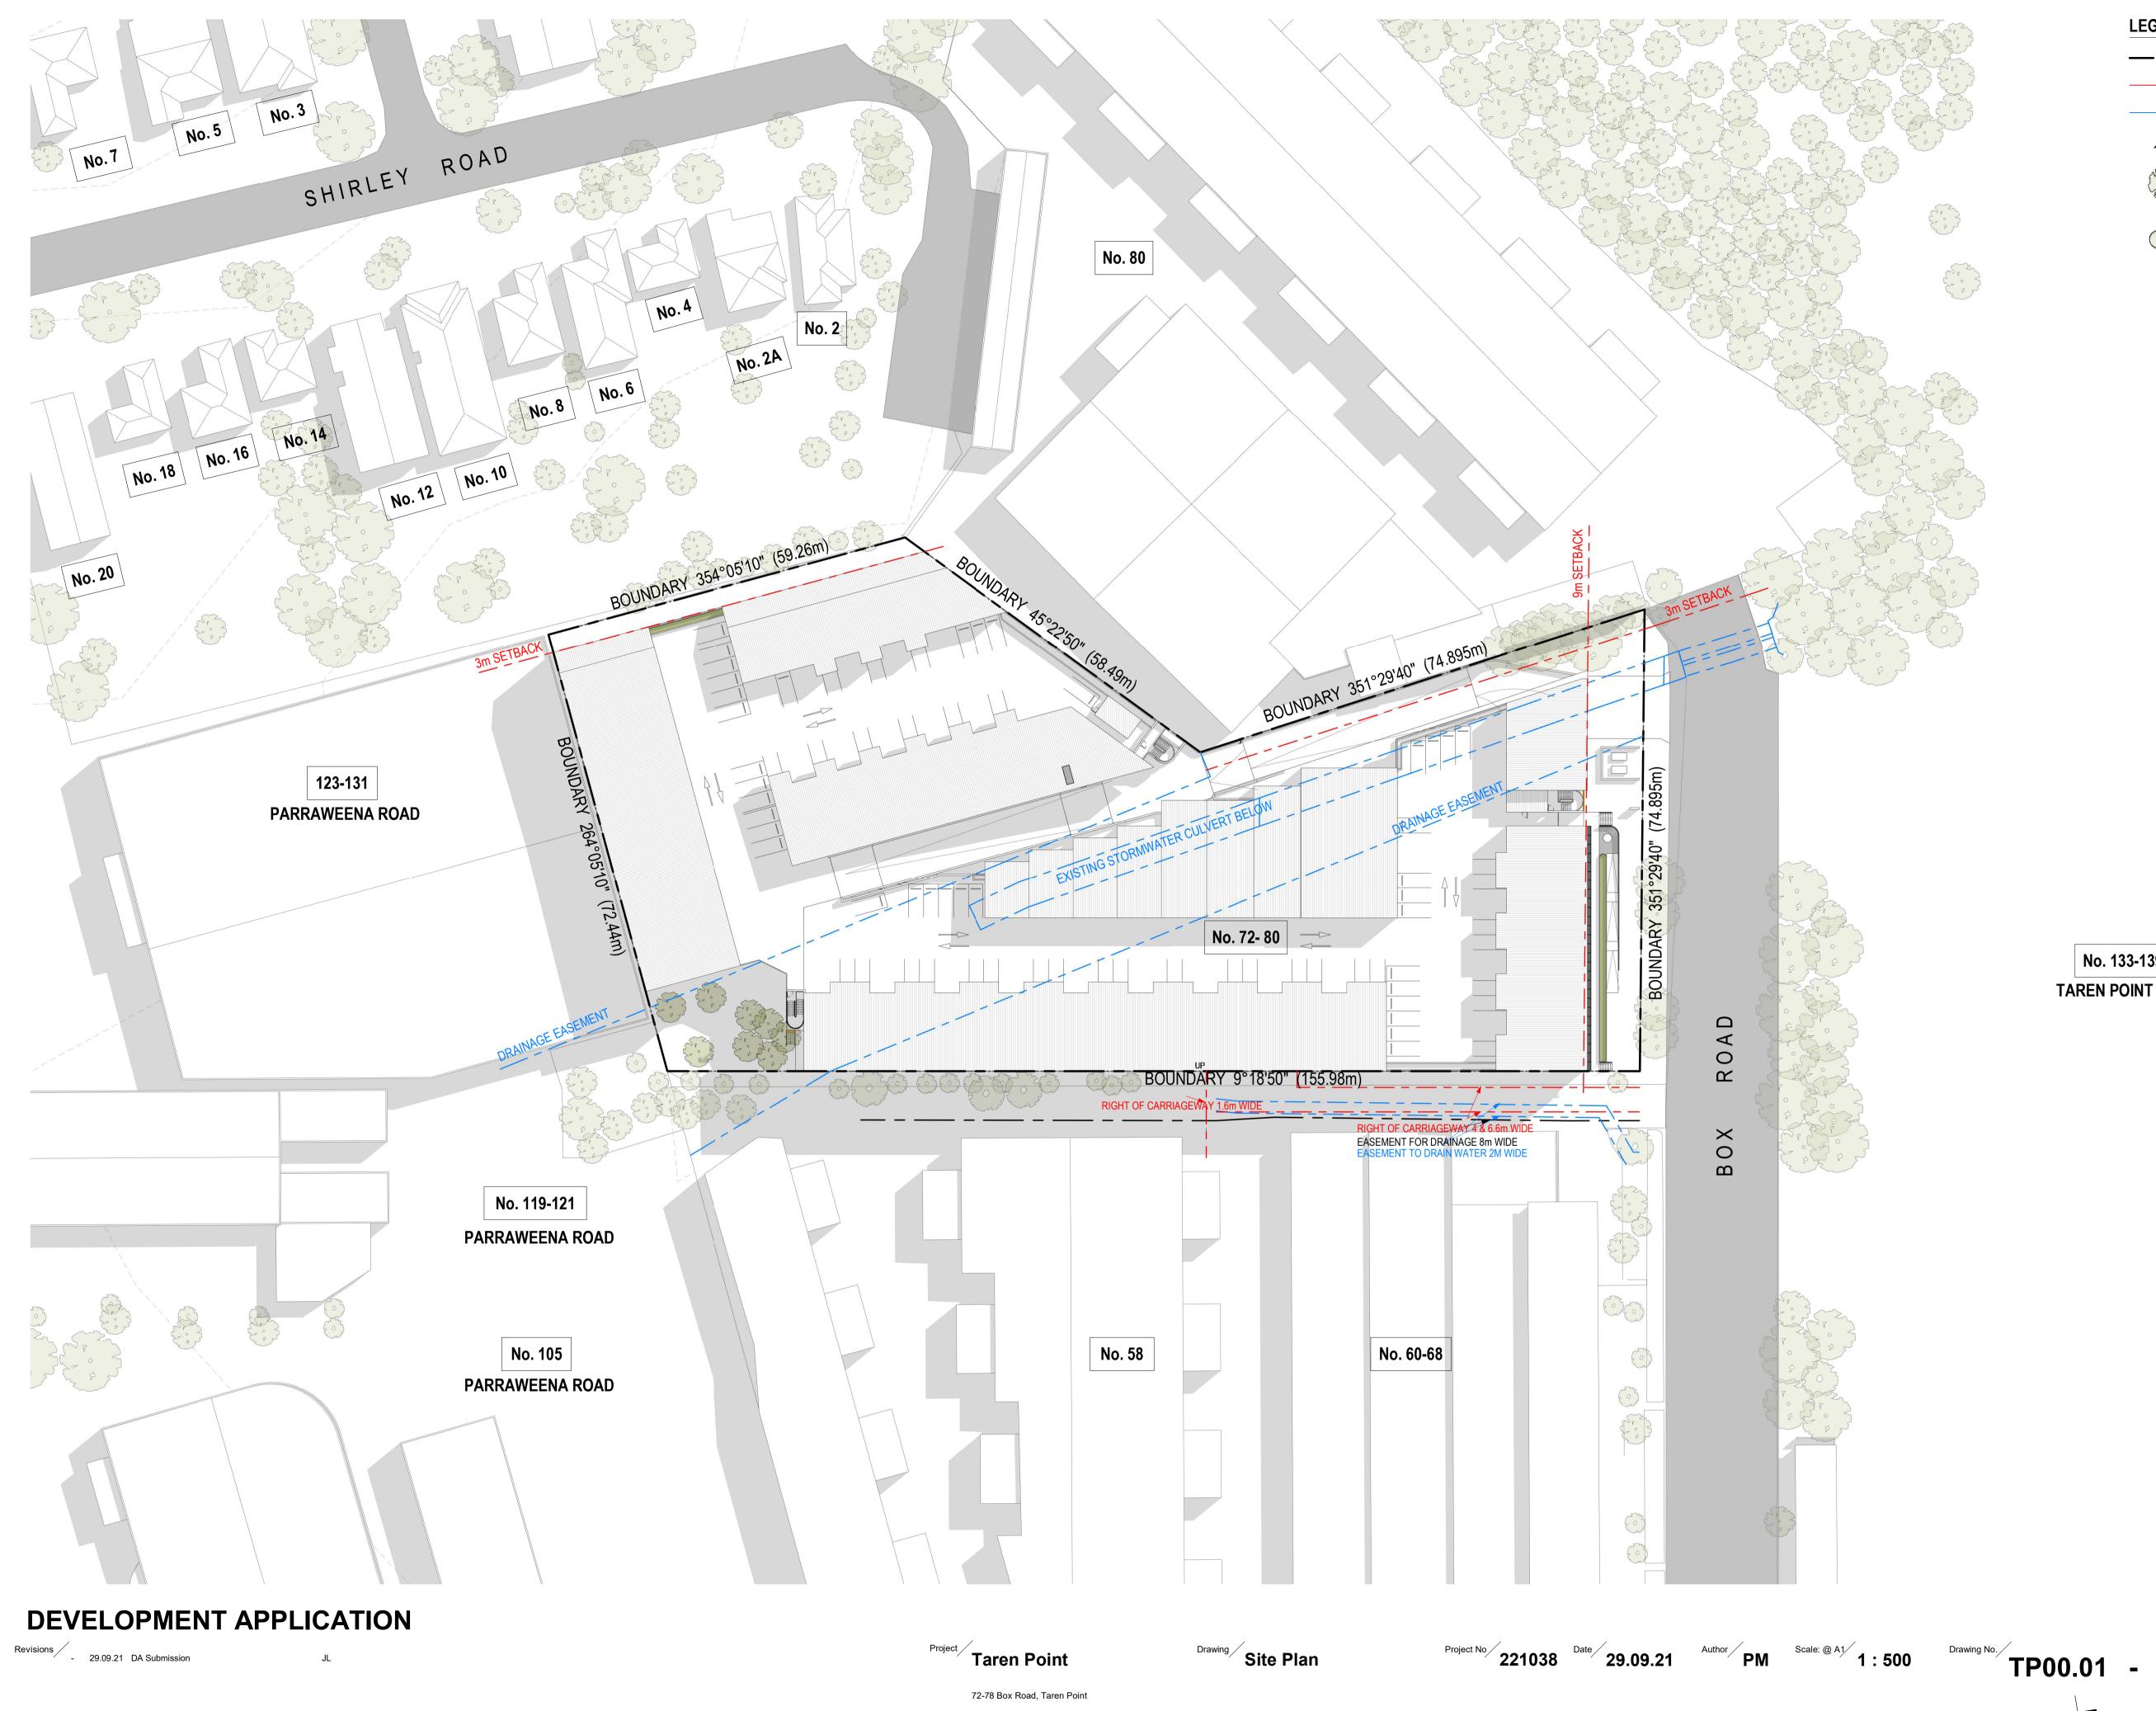
# **DEVELOPMENT APPLICATION**

 Project No
 Date

 221038
 04.04.22

Drawing No. Revision
















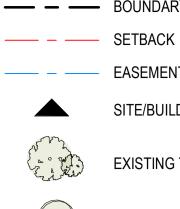

----- BOUNDARY LINE SITE/BUILDING ENTRY EXISTING TREES



No. 133-139


TAREN POINT ROAD

NEW TREES





## Staging Plan - Ground

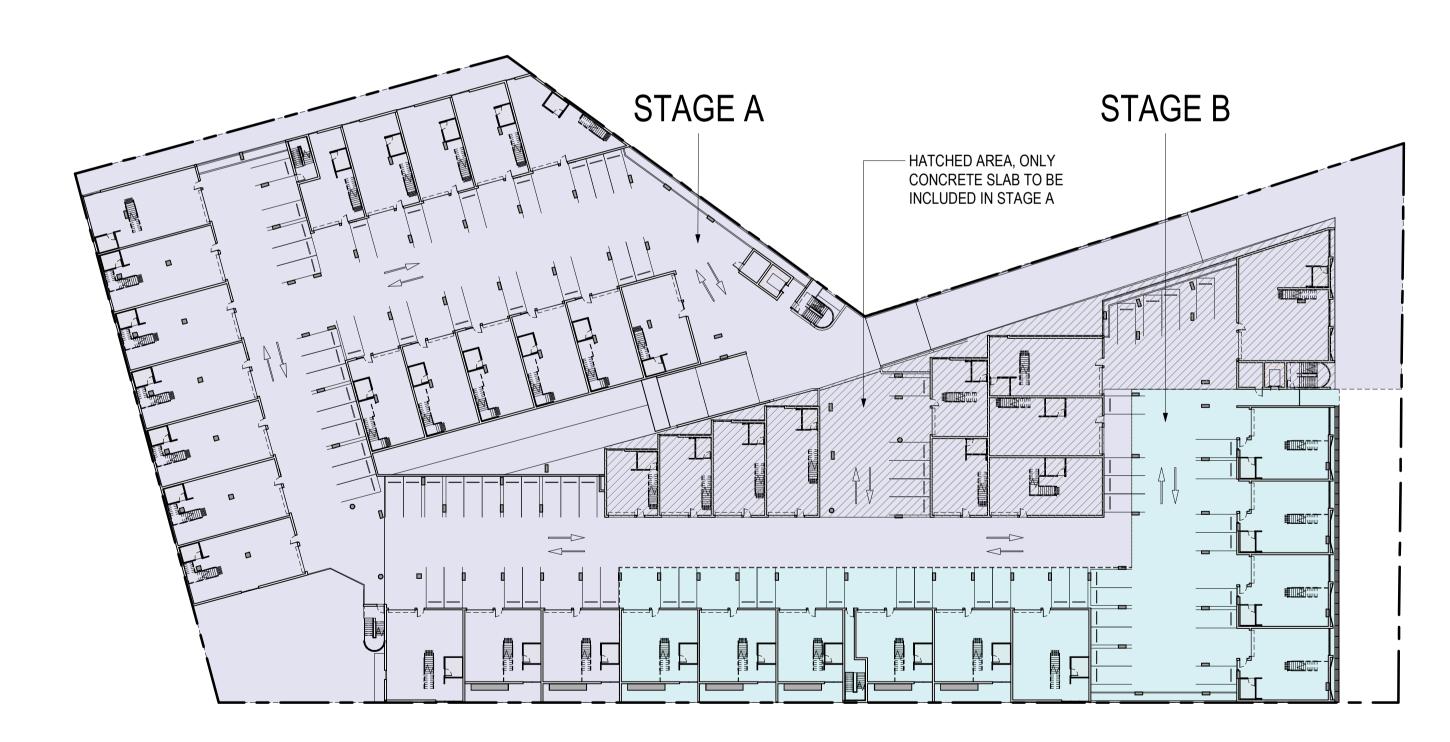


Staging Plan - Level 1

# **DEVELOPMENT APPLICATION**

JL

Revisions \_ 29.09.21 DA Submission

## 30/09/2021 2:49:44 PM

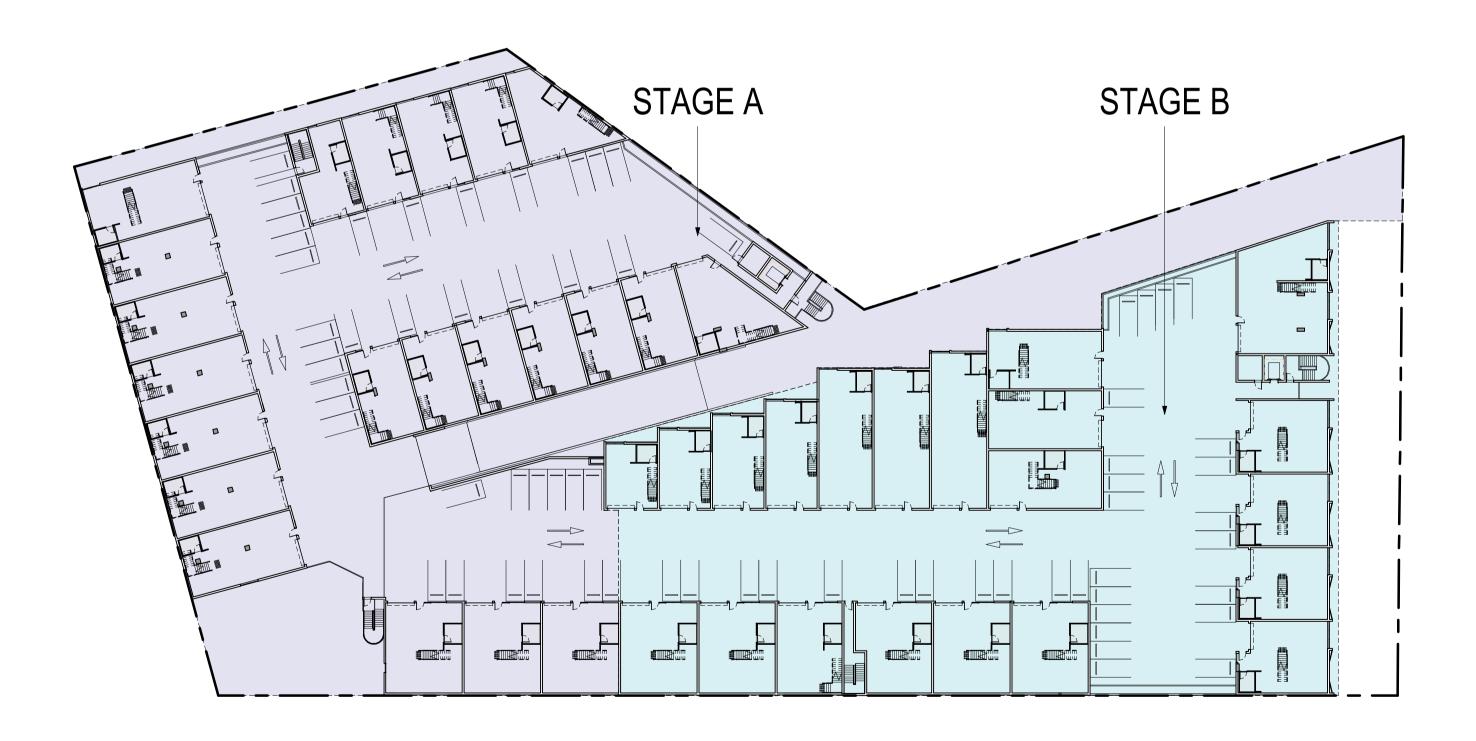





Drawing Staging Plan Project No 221038 Date 29.09.21

Author PM Scale: @ A1 1 : 500 Drawing No. TP00.02 -

72-78 Box Road, Taren Point

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### **Demolition Notes**

Contractor to confirm existing conditions on site. Contractor to demolish existing structure/remove all materials. Cut and seal services as required in accordance with local authority requirements and a.s. codes for that trade u.n.o

Protection of works as required by local authorities

Cleaning of site to epa requirements by contractor

Contractor to allow for complete demolition & removal of all asbestos products. All asbestos products to be removed & handled as per relevant Australian standards Extent of demolition work as indicated on this drawing ,

including but not limited to the following:

Removal/demolition of all existing floor/slabs & footings, external and internal walls, windows, doors, cladding, gutters, downpipes, rainwater heads, cappings, flashing gutter board supports etc. u.n.o

Removal/demolition of all existing works including but not limited to external steps, paths, carparks, planters & landscaping, gates, fences, garden walls, retaining walls, bollards, light blades signs, columns etc. u.n.o

Removal/demolition of all existing fixtures and fittings including but not limited to lights, taps, basins, wcs etc. Disconnection & removal of existing services to be undertaken by appropriate contractors

Contractor to make good damage to adjoining buildings, pavement, laneways, roads, fences, kerbs, channels, services, street furniture, carspace markings etc. (ie. Any adjoining objects/materials not within site boundary) resulting from demolition works.

All repairs to authority requirements or to condition prior to demolition. Contractors are responsible for relocation and co-ordination of road carparking markings, ticket machines etc.

### Preliminary

Precautionary measures to be undertaken as described in AS.2601-2001. A "hazardous substances management plan" is to be implemented before and during demolition if the preliminary investigation of the building identifies any hazardous materials contained therein. These materials will be removed as per the guidelines of the responsible authority and clearance certificate obtained before demolition commences

### Safety fencing

Security fences shall be provided to the street boundary of the demolition site and any additional precautionary measures, taken as may be necessary to prevent unauthorised entry to the site, where the demolition site adjoins a public thoroughfare the common boundary between them shall be fenced for its full length with a hoarding unless the least horizontal distance between the common boundary and the nearest part of the structure is greater than twice the height of the structure. The fencing shall be the equivalent of the chain wire as specified in AS.1725

Notices lettered in accordance with AS.1319 and displaying the words "warning demolition in progress", or similar, shall be fixed to the fencing at appropriate places to warn the public. Provision shall be made for ready access to the site by emergency services personnel in the event of fire or accident

### Demolition work

Structures shall be demolished in the reverse order to that of their construction. The order of demolition for buildings shall be progressive, storey by storey, having proper regard to the type of construction. No part of any structure shall be left unsupported or unattended in such a condition that it may collapse or become dangerous. Precautions shall be taken to ensure that the stability of all parts of the structure, and the safety of persons on and outside the site, will be maintained in the event of sudden and severe weather changes.

Walls on the boundaries are to be demolished in a safe and workmanship like manner. Walls shall not be laterally loaded by accumulated debris or rubble, to the extent that they are in danger of collapse, allowable loading of the suspended floors shall be determined by an independent structural engineer.

### Dust control

The techniques adopted for stripping out and for demolition shall minimise the release of dust into the atmosphere. Before the commencement of stripping or demolition in an area of a structure, any existing accumulations of dust in that area shall be collected, placed in suitable containers and removed. Selection of an appropriate collection technique, such as vacuuming or hosing down, shall take due account of the nature of the dust and the type of hazard it presents. Dust generated during stripping, or during the breaking down of the building fabric to removable sized pieces, shall be kept damp until it is removed from the site or can be otherwise contained. The use of excess water for this purposed shall be avoided.

### **Noise control** Noise shall be minimised as far as practicable, by the

selection of appropriate methods and equipment, and by the use of silencing devices wherever practicable to epa/code requirements. Note: 1. Attention is drawn to recommendations in AS.2436

2. Hours of operating equipment may be restricted by regulatory authority

### Fire services


Where a fire hydrant service or a fire hose reel service is provided in a building, it shall be available at all times during the demolition of the building, so that all remaining storeys except the two uppermost storeys, are serviced. Access to the fire protection services, including any booster fitting, shall be maintained at all times. If a sprinkler system is installed in a building to be demolished, it shall be maintained in an operable condition at each storey below the two uppermost unstripped storeys. Suitable portable fire extinguishers shall be kept at all times in working area and are not protected by other fire services, and maintained in an operable condition.

### Adjoining properties

Safe access to and egress from adjoining buildings shall be maintained at all times for the duration of the demolition work. No demolition activity shall cause damage to or adversely affect the structural integrity of adjoining buildings. The effects of vibration and conversion on adjoining buildings and their occupants shall be minimised by selecting demolition methods and equipment appropriate to the circumstances. Where any surface of an adjoining building is exposed by demolition, the need for weatherproofing the exposed surface shall be investigated and temporary or permanent protection provided as appropriate. Precautions shall be taken to minimise the spreading of mud and debris by vehicles leaving the site.

### General

Openings in existing walls and floors, through which there is a risk of persons falling to lower level, shall be either properly guarded or boarded over and the boarding secured against unauthorised or accidental removal. Precautions shall be taken to prevent glass from falling on any person in or outside the building. Demolished material shall not be allowed to fall freely outside the structure unless it is confined within a chute or similar enclosure, which is clear of obstructions to objects falling freely. Demolished material shall be removed progressively from the site and at any time, shall not be allowed to accumulate to the extent that it presents a hazard to the public or to site personnel.

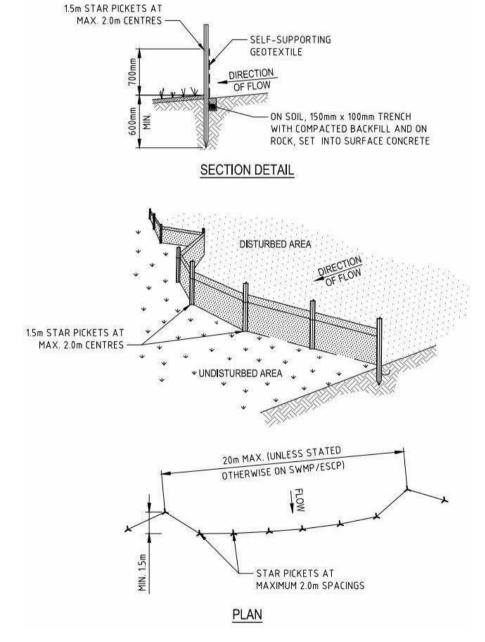


SEDIMENT FENCE

- NOTE 1. CONSTRUCT SEDIMENT FENCE AS CLOSE AS POSSIBLE TO BEING PARALLEL TO
- THE CONTOURS OF THE SITE, BUT WITH SMALL RETURNS AS SHOWN TO LIMIT THE CATCHMENTS AREA OF ANY ONE SECTION. THE CATCHMENTS AREA SHOULD BE SMALL ENOUGH TO LIMIT WATER FLOW IF CONCENTRATED AT ONE POINT TO 50I/s IN THE DESIGN STORM EVENT, USUALLY THE 10-YEAR EVENT.
- CUT A 200mm DEEP TRENCH ALONG THE UPSLOPE LINE OF THE FENCE FOR THE FABRIC TO BE ENTRENCHED.
   DRIVE 1.5m LONG STAR PICKETS INTO GROUND AT 2m INTERVALS AT
- DOWNSLOPE EDGE OF THE TRENCH. ENSURE ANY STAR PICKET ARE FITTED WITH SAFETY CAPS.
  FIX SELF SUPPORTING GEOTEXTILE TO THE UPSLOPE SIDE OF POSTS
- ENSURING IT GOES TO THE BASE OF THE TRENCH. FIX THE GEOTEXTILE WITH WIRE OR AS RECOMMENDED BY THE MANUFACTURER. ONLY USE GEOTEXTILE SPECIFICALLY PRODUCED FOR SEDIMENT FENCING. 5. JOIN SECTIONS OF FABRIC AT SUPPORT POST WITH A 150mm OVERLAP.
- 6. BACKFILL THE TRENCH OVER THE BASE OF THE FABRIC AND COMPACT IT THOROUGHLY OVER THE GEOTEXTILE.

## **DEVELOPMENT APPLICATION**

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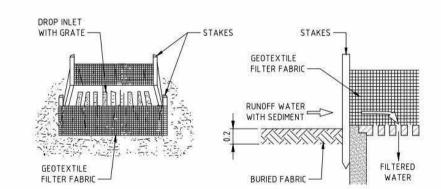

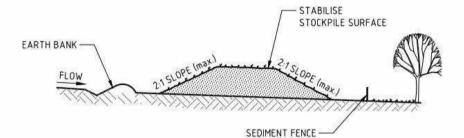
### STOCKPILE NOTE

1. PLACE STOCKPILES MORE THAN 2m FROM EXISTING VEGETATION, CONCENTRATED WATER FLOW, ROADS AND HAZARD AREAS.

COMPACT IT THOROUGHLY OVER THE GEOTEXTILE.


- CONSTRUCT ON THE CONTOUR AS LOW, FLAT, ELONGATED MOUNDS.
   WHERE THERE IS SUFFICIENT AREA, TOPSOIL STOCKPILES SHALL BE LESS
- THAN 2m IN HEIGHT. CONSTRUCT EARTH BANKS ON THE UPSLOPE SIDE TO DIVERT WATER AROUND STOCKPILES AND SEDIMENT FENCES 1 TO 2m DOWNSLOPEBACKFILL THE TRENCH OVER THE BASE OF THE FABRIC AND



### GEOTEXTILE INLET FILTER

- NOTE
   FABRICATE A SEDIMENT BARRIER MADE FROM GEOTEXTILE OR STRAW BALES.
   CUT A 200mm DEEP TRENCH ALONG THE UPSLOPE LINE OF THE FENCE FOR
- THE FABRIC TO BE ENTRENCHED.
  3. DRIVE 1m LONG STAR PICKETS INTO GROUND AT THE FOUR CORNERS OF PIT WALLS. ENSURE ANY STAR PICKET ARE FITTED WITH SAFETY CAPS.
- 4. FIX SELF SUPPORTING GEOTEXTILE TO THE UPSLOPE SIDE OF POSTS ENSURING IT GOES TO THE BASE OF THE TRENCH. FIX THE GEOTEXTILE WITH WIRE OR AS RECOMMENDED BY THE MANUFACTURER. ONLY USE GEOTEXTILE SPECIFICALLY PRODUCED FOR SEDIMENT FENCING.
- JOIN SECTIONS OF FABRIC AT SUPPORT POST WITH A 150mm OVERLAP.
   BACKFILL THE TRENCH OVER THE BASE OF THE FABRIC AND COMPACT IT THOROUGHLY OVER THE GEOTEXTILE.

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Scale: @ A1 **1 : 500** 

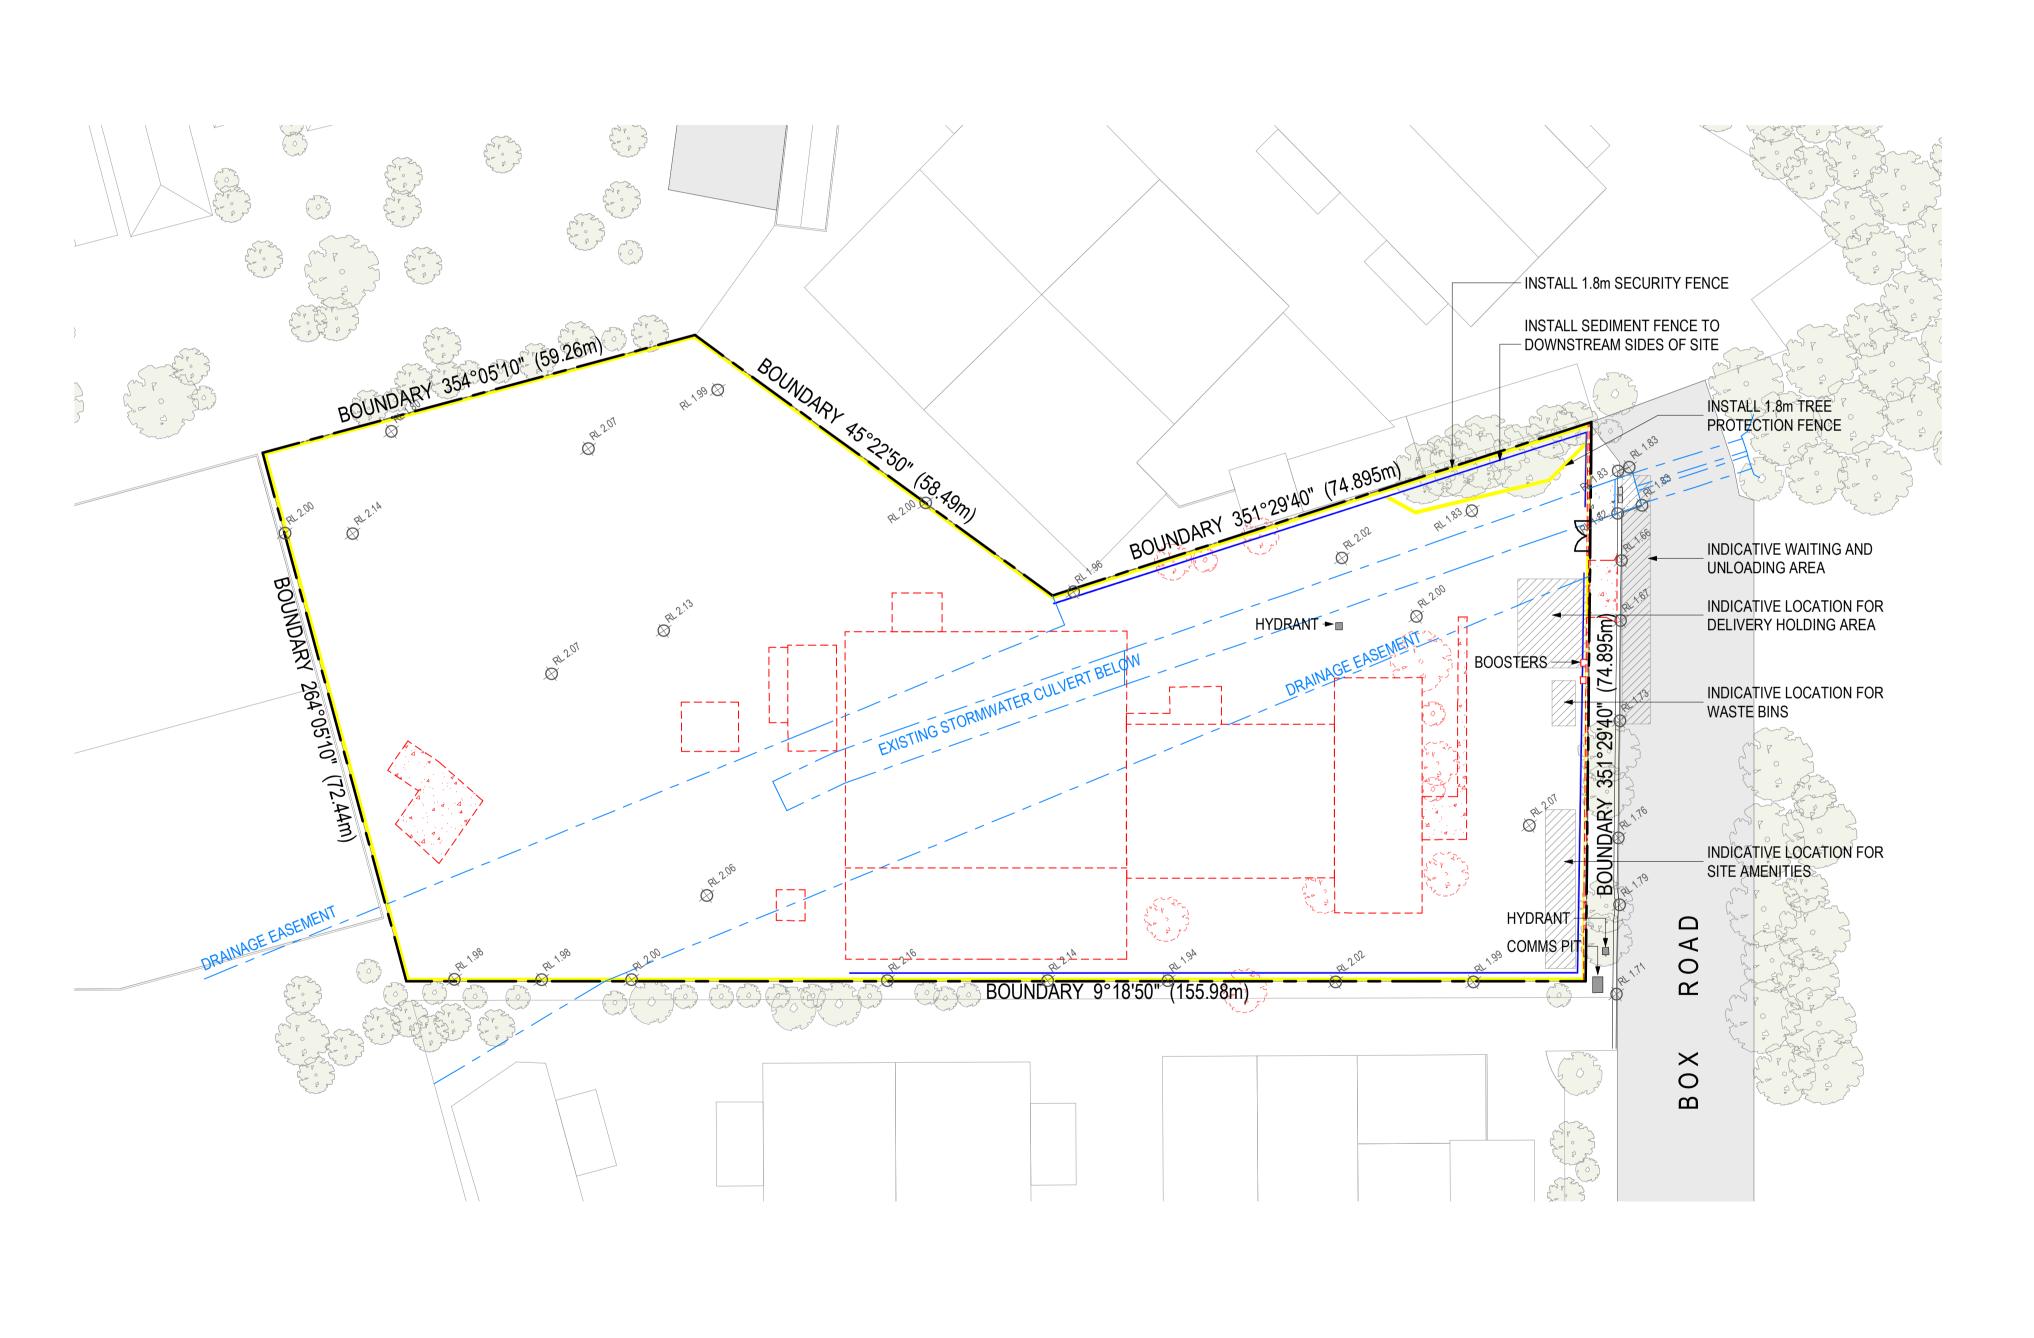Drawing No.

**TP00.03** -

Author

<sup>\*</sup> 29.09.21

221038

## Project Taren Point

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# Demolition / Existing / Construction Management

72-78 Box Road, Taren Point

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Plan

### LEGEND

 BOUNDARY LINE

 BUILDINGS TO BE DEMOLISHED


 SEXISTING TREES TO BE REMOVED

 SEDIMENT CONTROL FENCE

 SECURITY FENCE

 SITE GATE



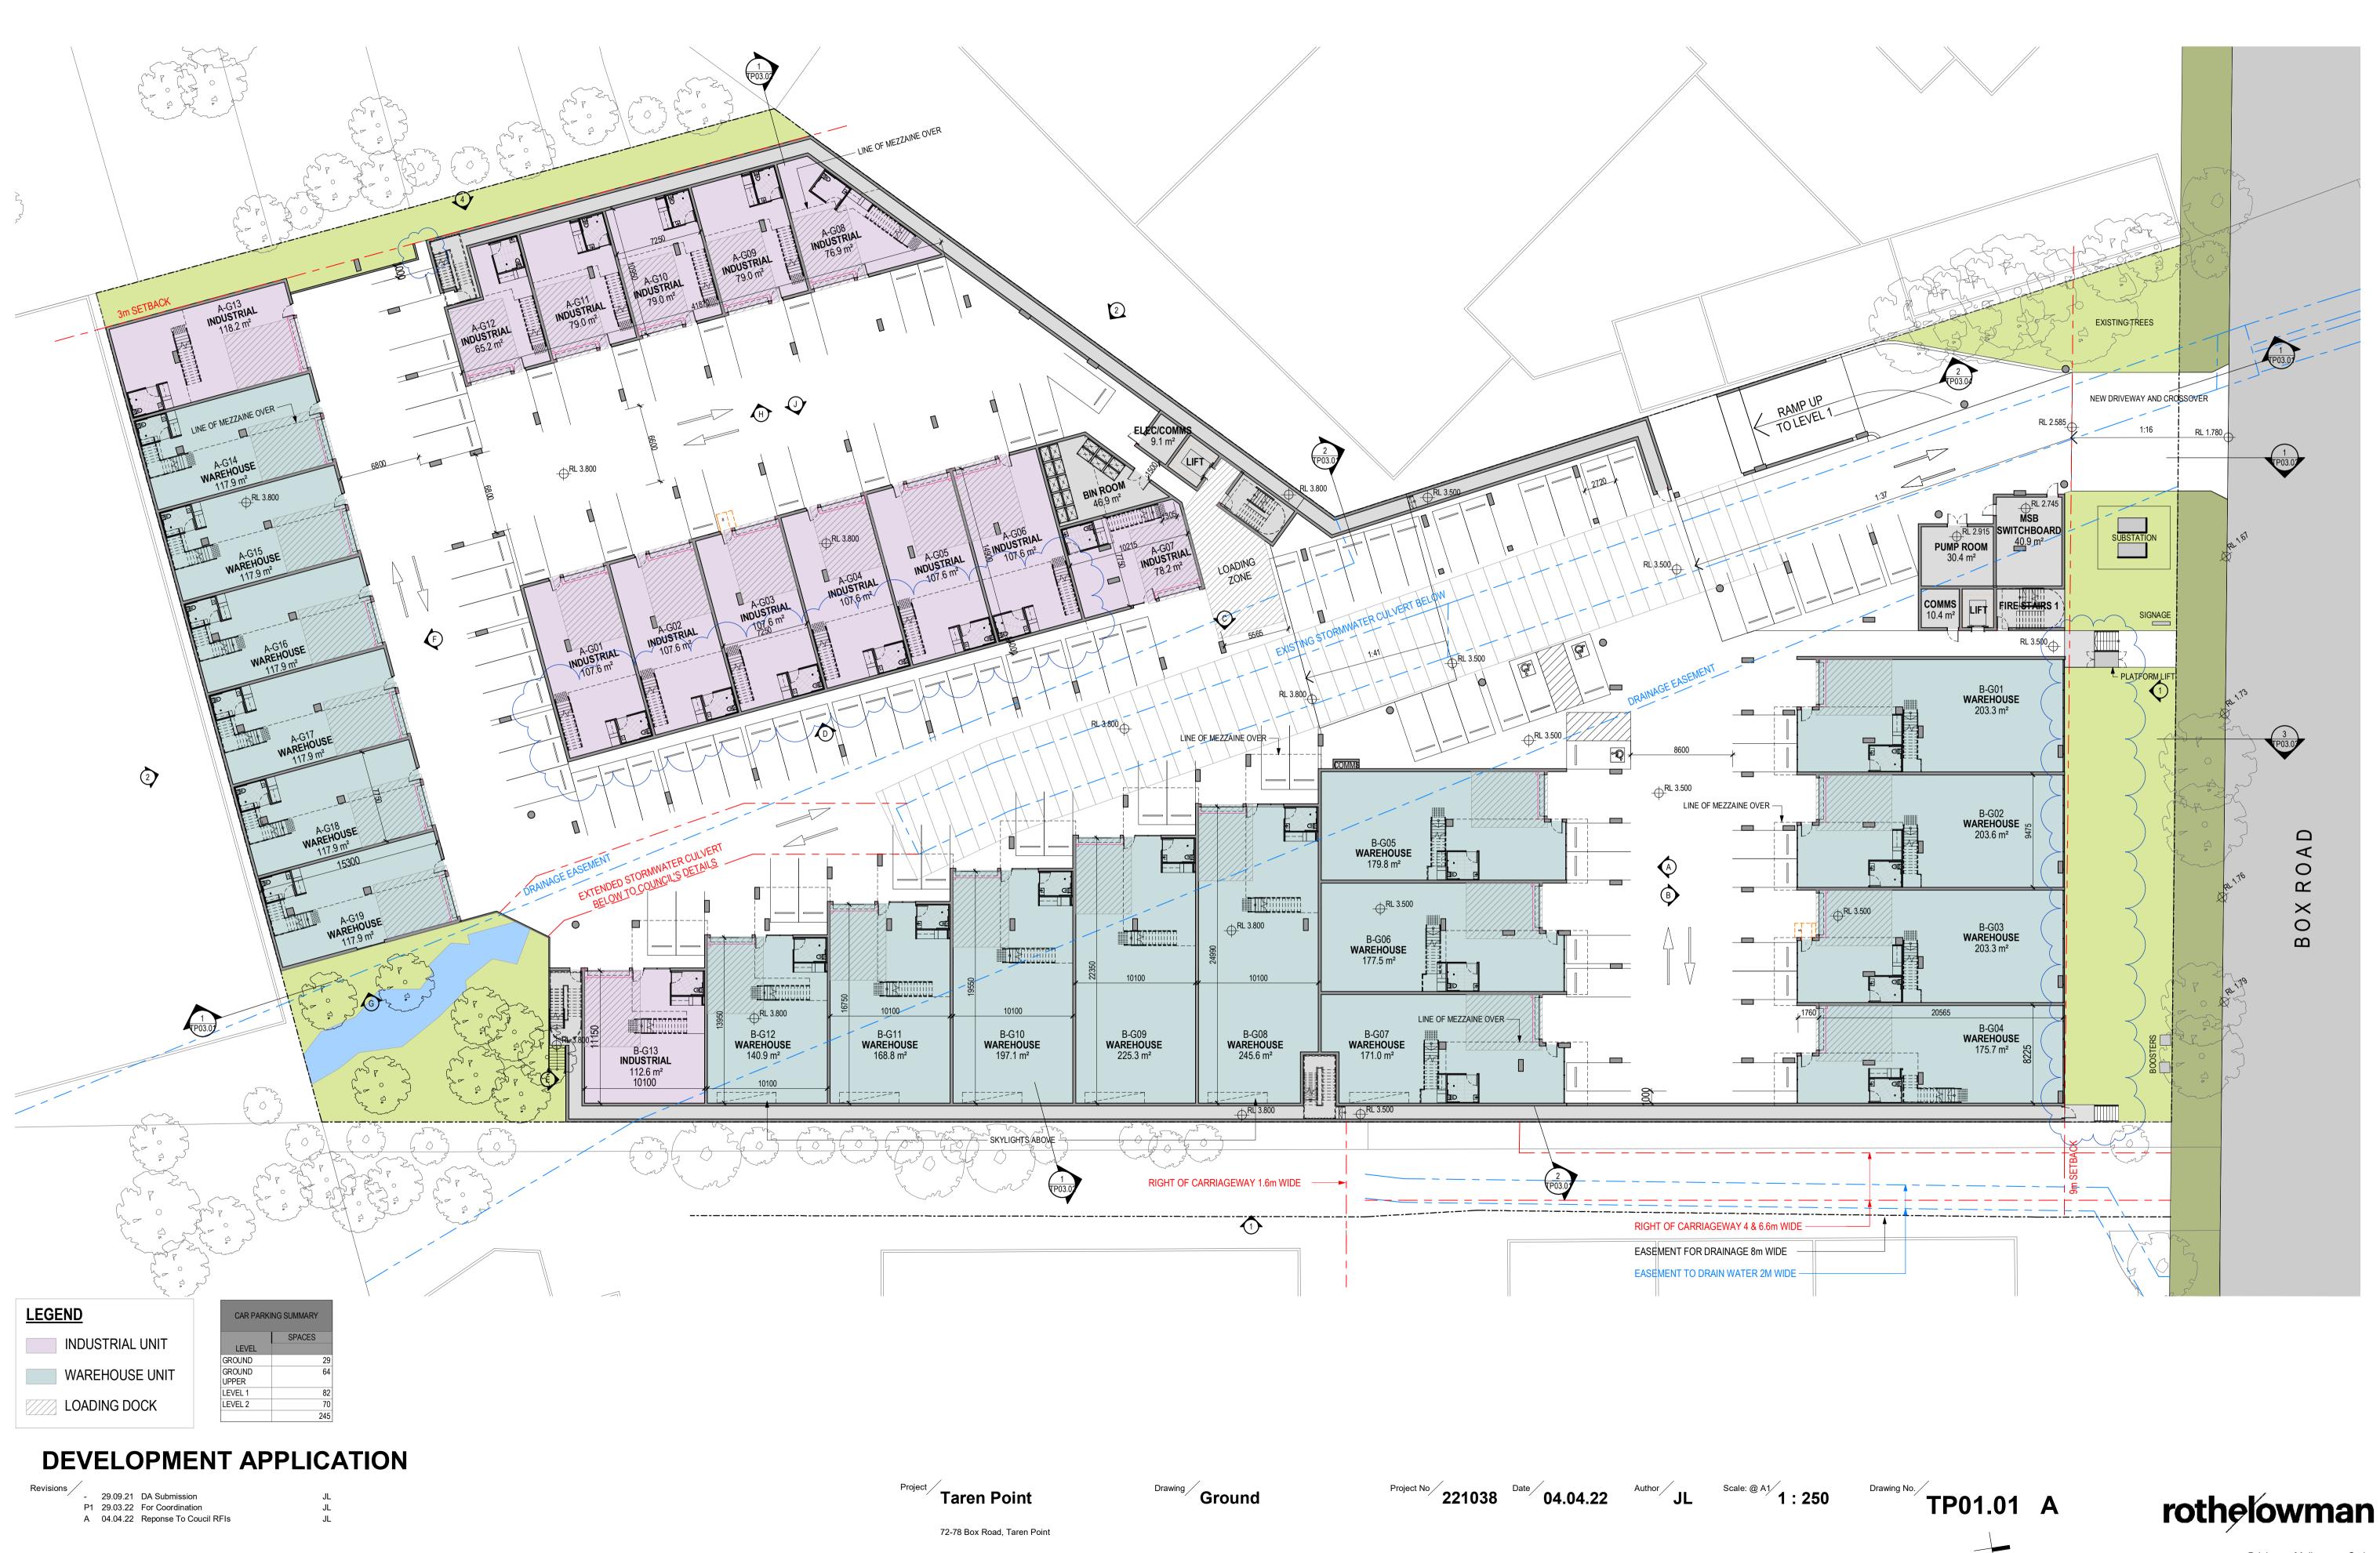

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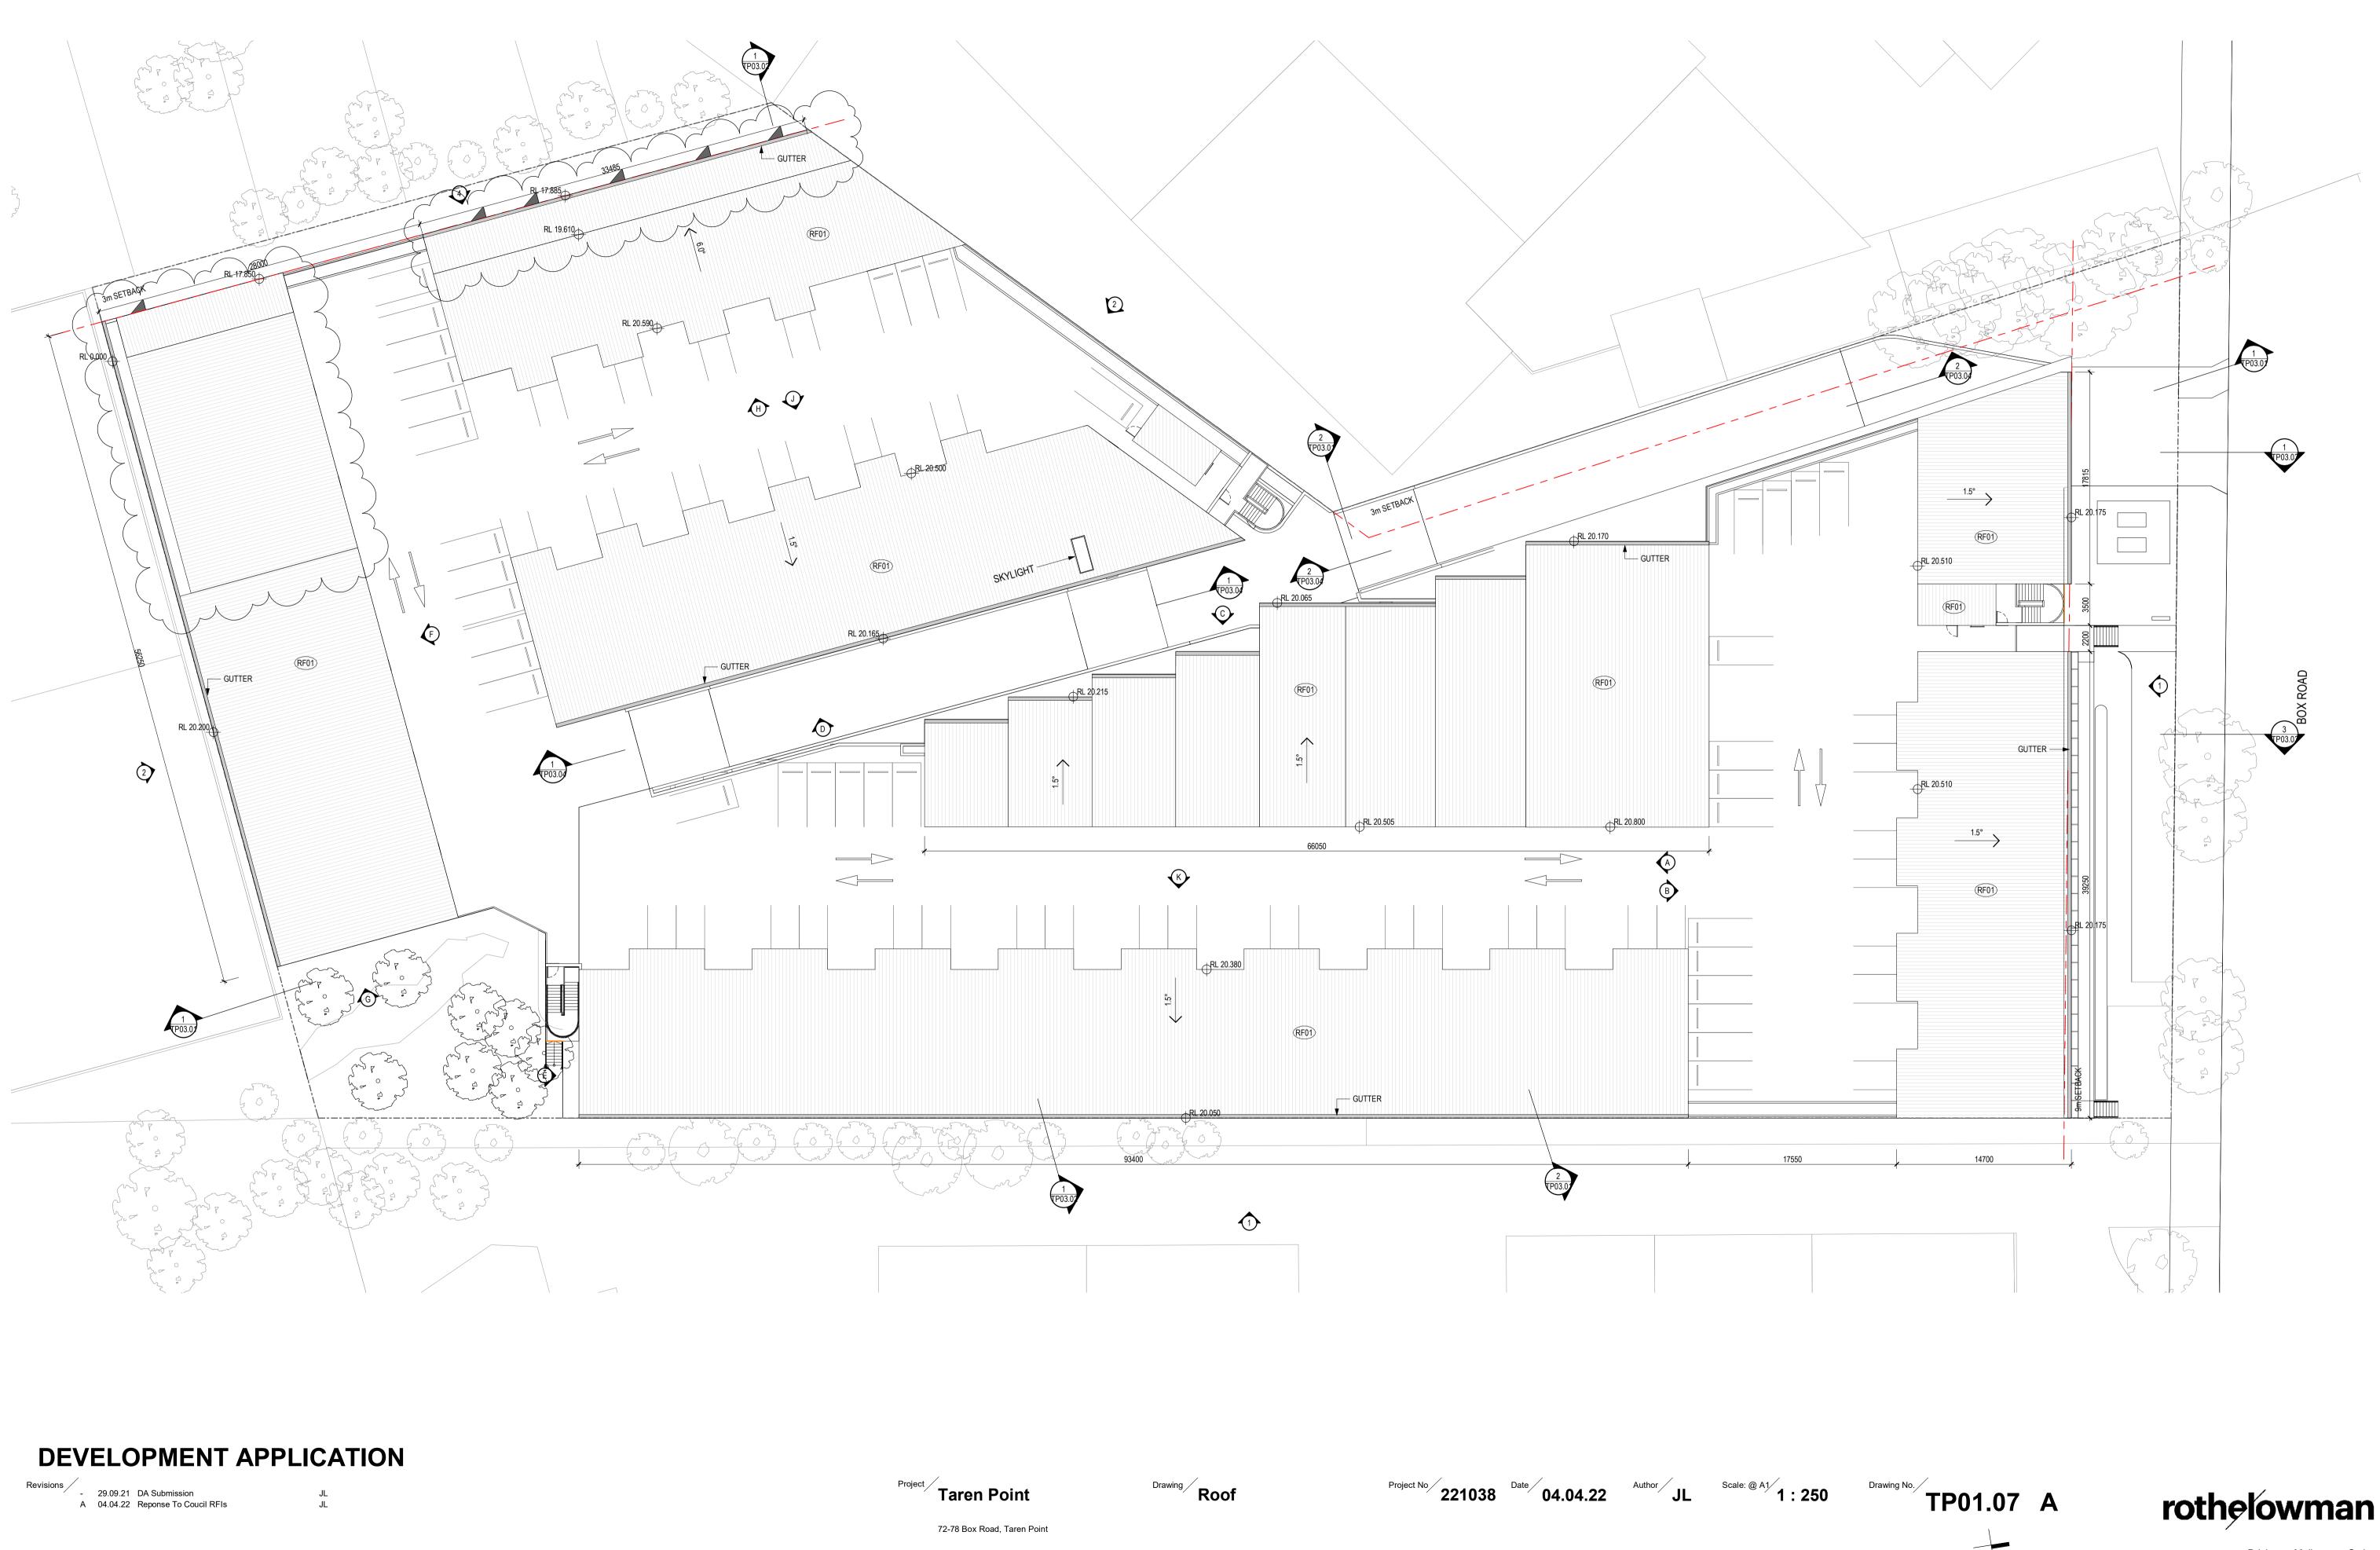
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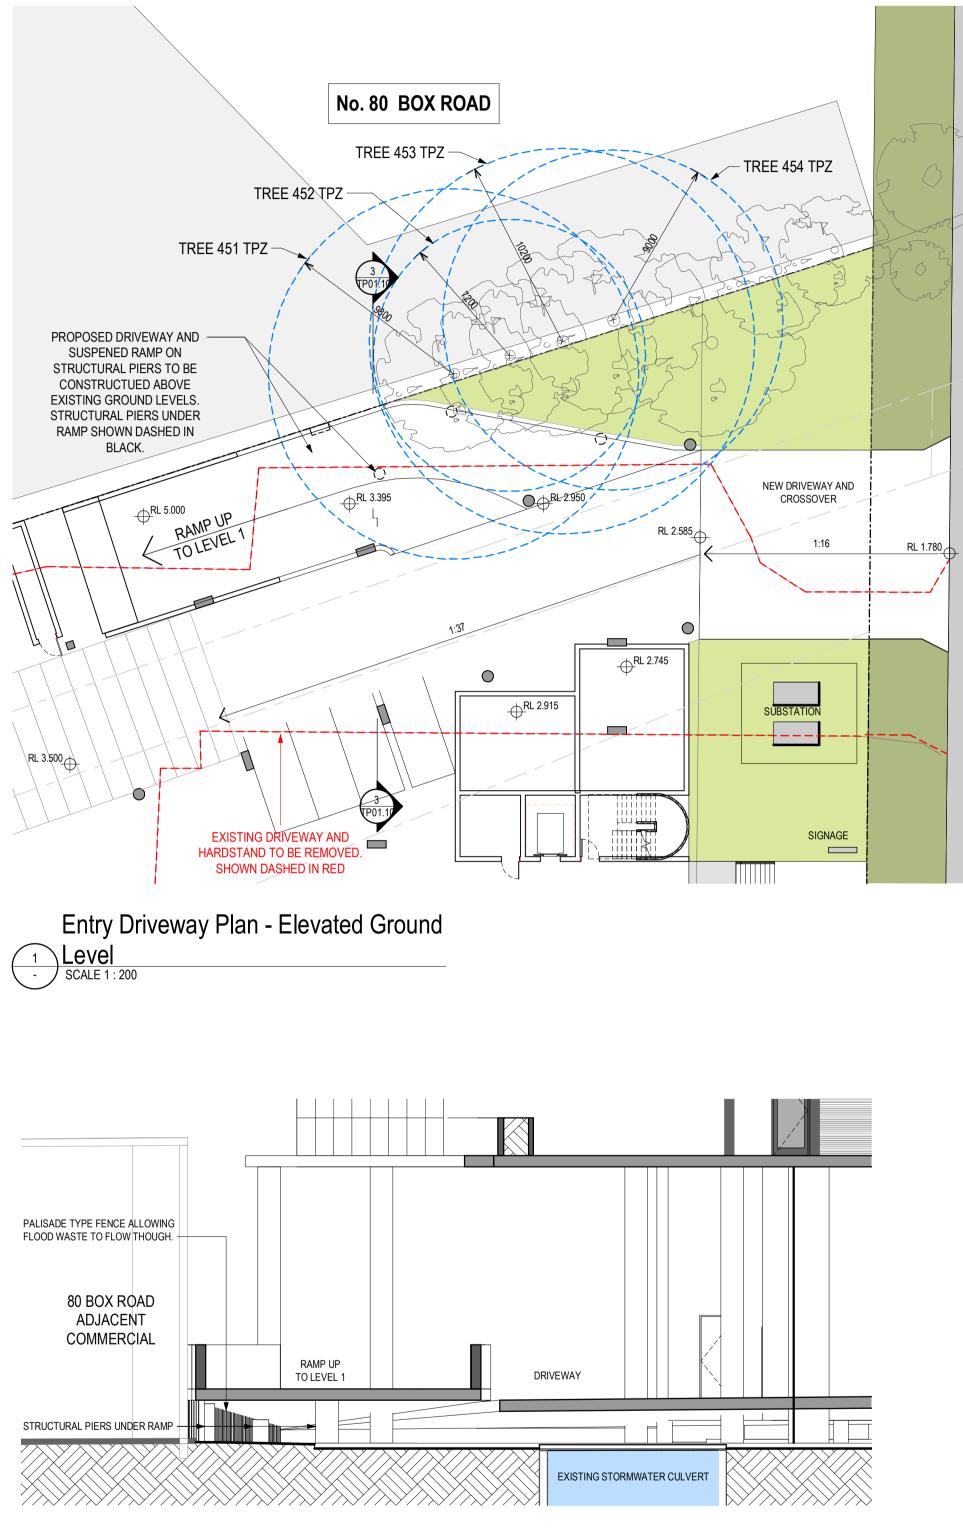
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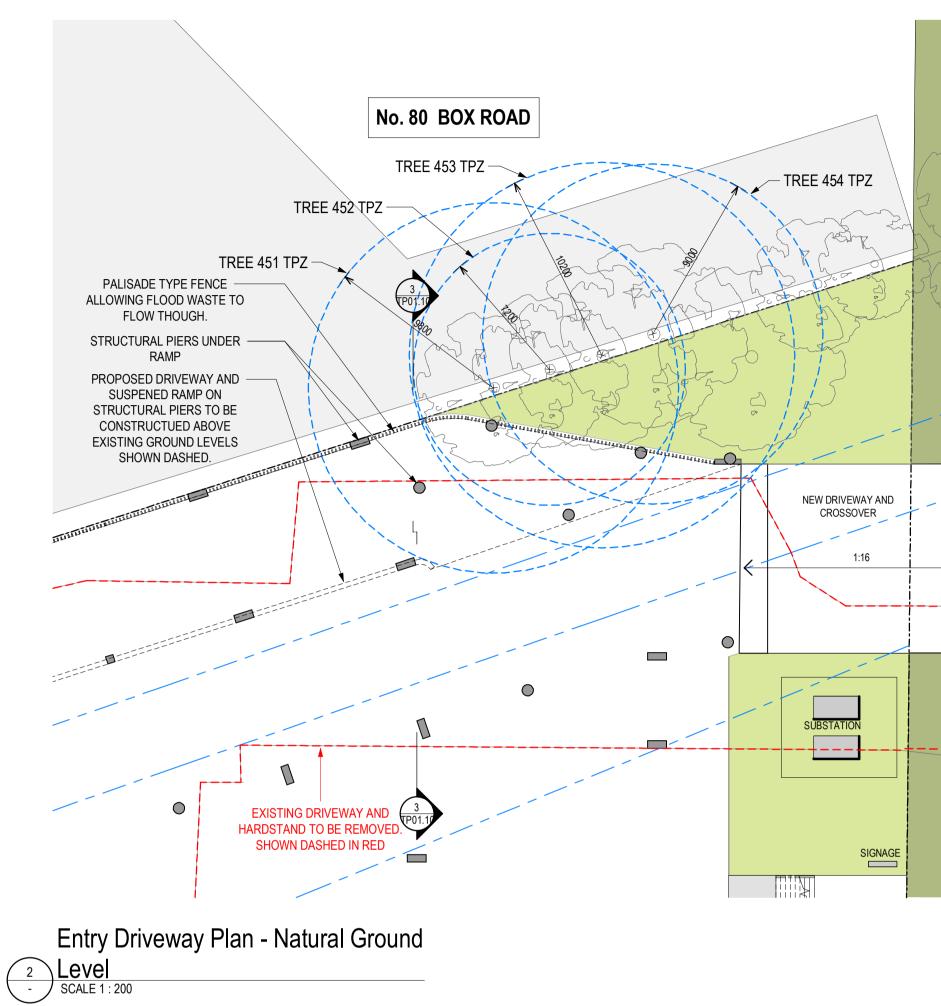
3 Ramp Detail Section SCALE 1: 100

# **DEVELOPMENT APPLICATION**

JL

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BOX

ROAD

# Project Taren Point

Entry Driveway Plan


Project No 221038 Date 04.04.22

Author JL Scale: @ A1 As

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72-78 Box Road, Taren Point

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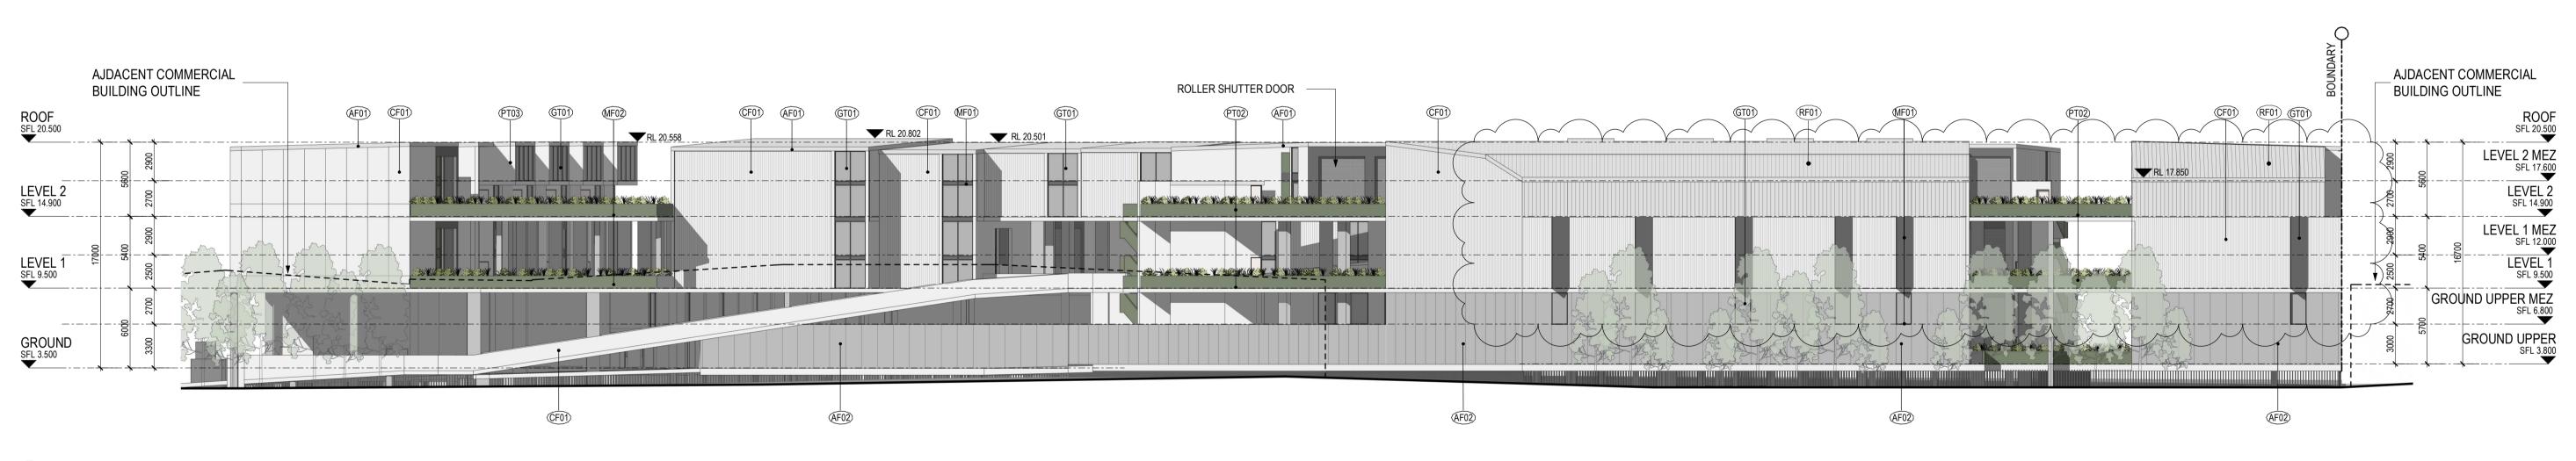


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Drawing No.

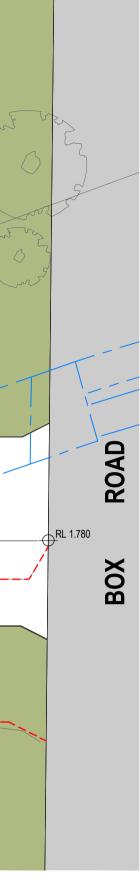

North Street Elevation



## West Elevation


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CF01 Concrete - Light	MF01 Charcoal Coloured Finish			
CF02 Concrete - Grey	MF02 Green Coloured Finish			
CS01 Charcoal Coloured Finish	PT01 Paint Finish - Charcoal			
CS02 Bronze Coloured Finish	PT02 Paint Finish - Green			
AF01 Applied Finish - Light Grey	PT03 Paint Finish - White			
GT01 Glazing Clear	RF01 Metal Deck Roofing - Light Grey			
DEVELOPMENT APPLICATION				
Revisions _ 29.09.21 DA Submission	JL			


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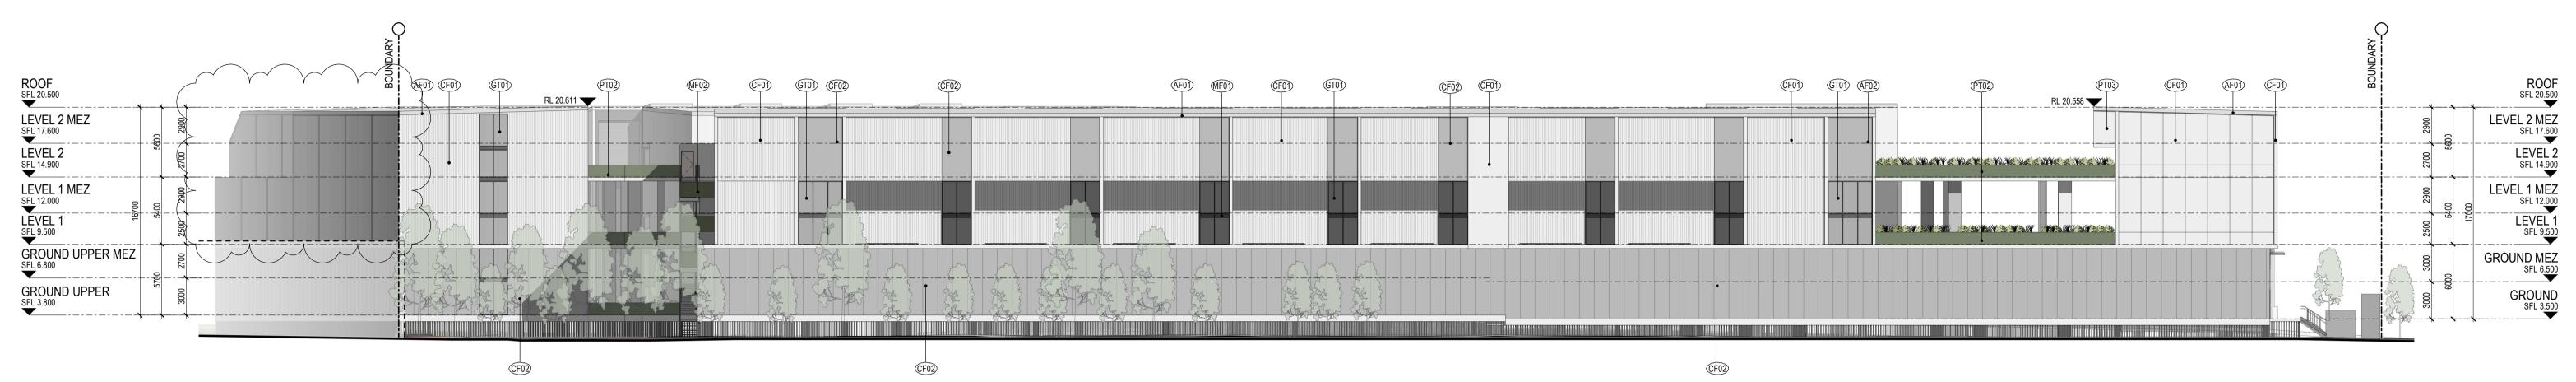


## North-West Elevation




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## East Elevation

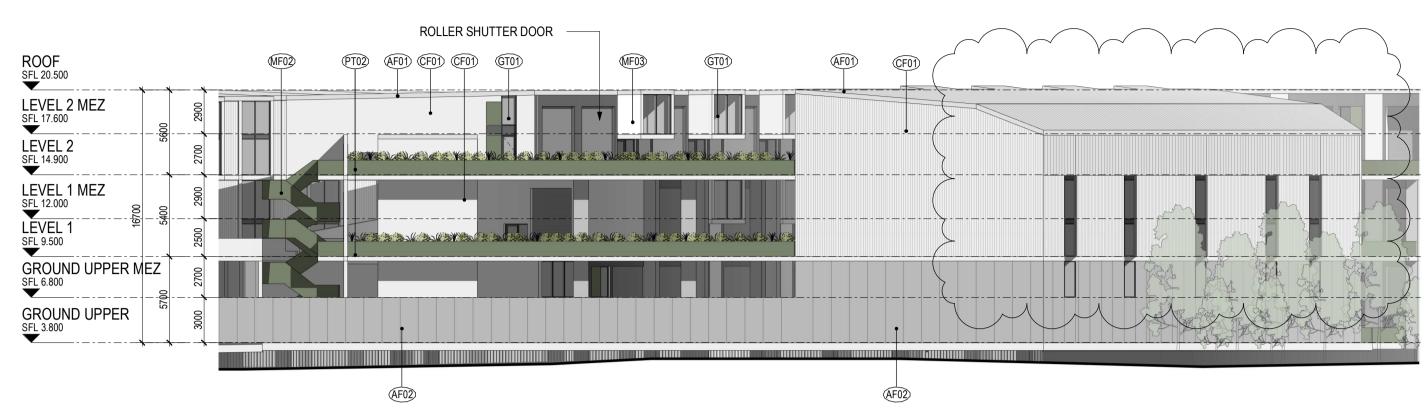
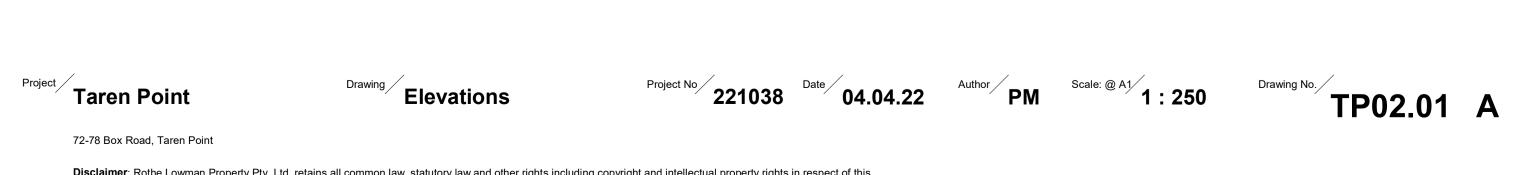
## South Elevation

LEGEND	)
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CF01 Concrete - Light	MF01 Charcoal Coloured Finish			
CF02 Concrete - Grey	MF02 Green Coloured Finish			
CS01 Charcoal Coloured Finish	PT01 Paint Finish - Charcoal			
CS02 Bronze Coloured Finish	PT02 Paint Finish - Green			
AF01 Applied Finish - Light Grey	PT03 Paint Finish - White			
GT01 Glazing Clear	RF01 Metal Deck Roofing - Light Grey			
DEVELOPMENT APPLICATION				
Revisions - 29.09.21 DA Submission	JL			
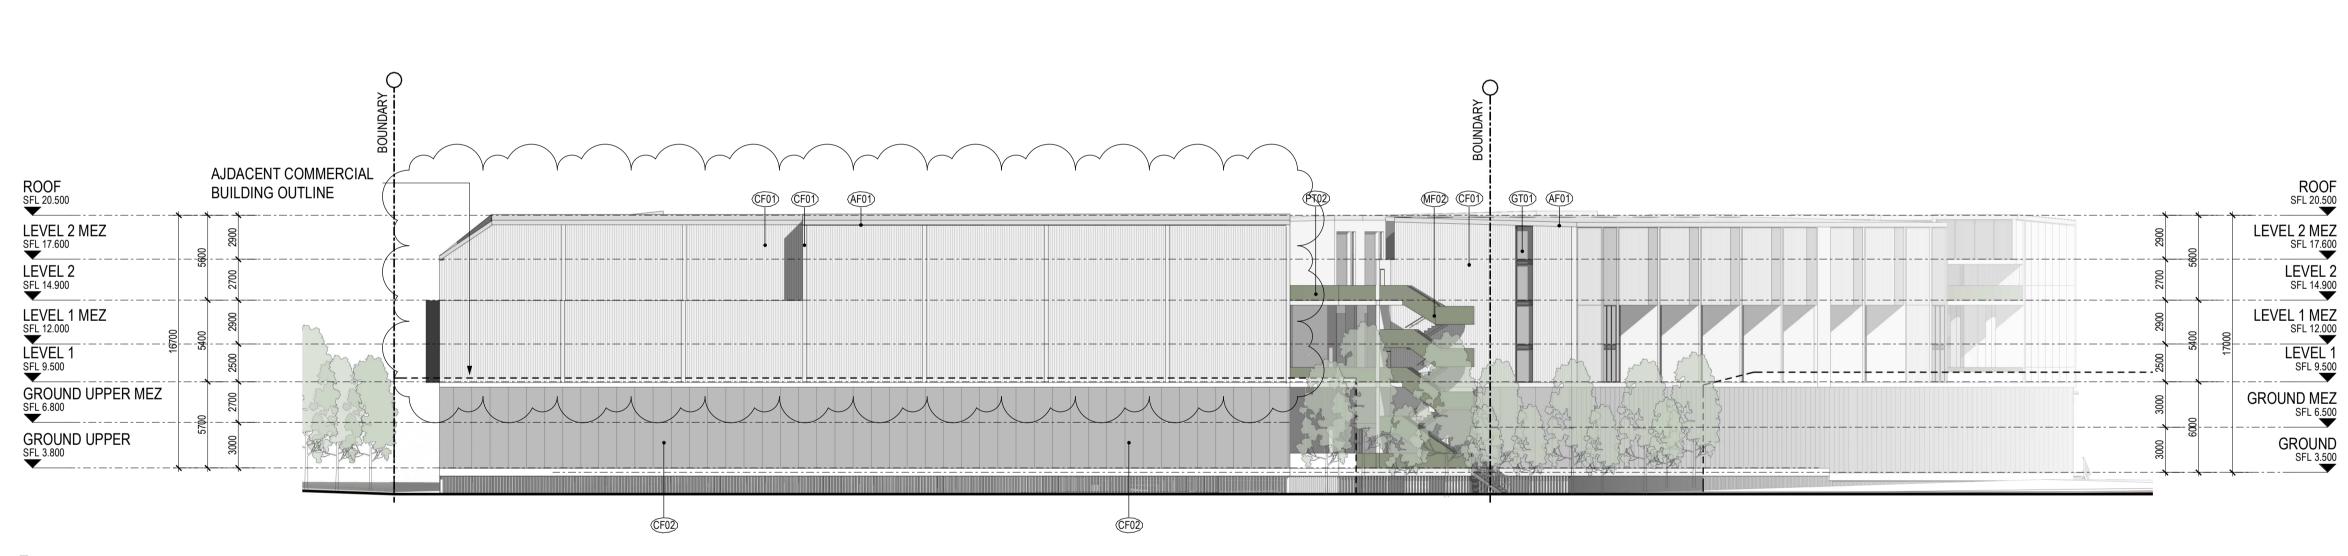
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# Project Taren Point


**Elevations** 


Project No 221038 Date 04.04.22 Author PM Scale: @ A1 1 : 250 Drawing No. TP02.02 A

72-78 Box Road, Taren Point


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## Elevation C

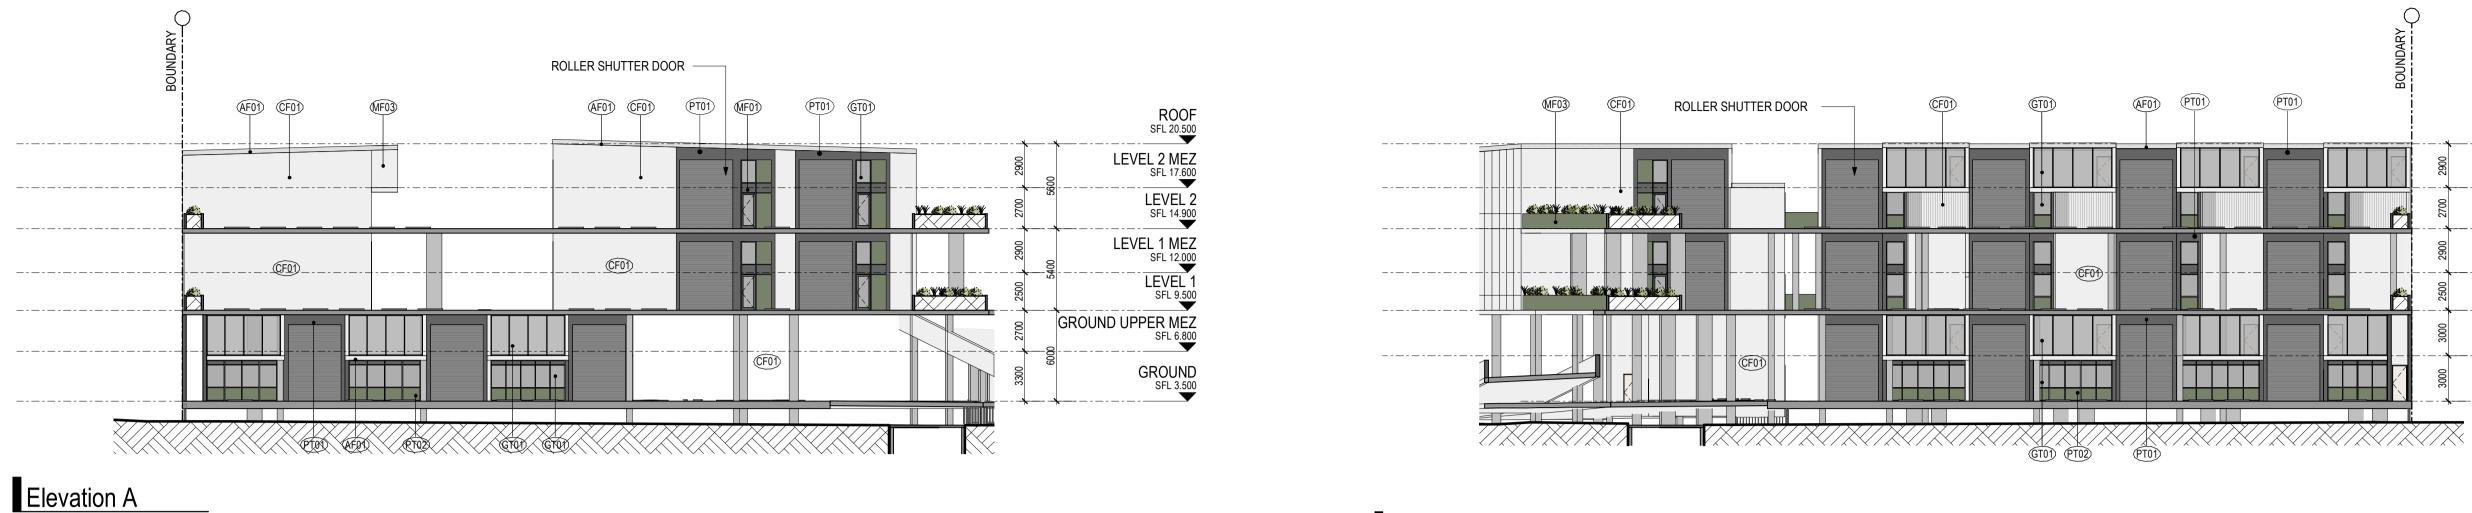

Elevation D

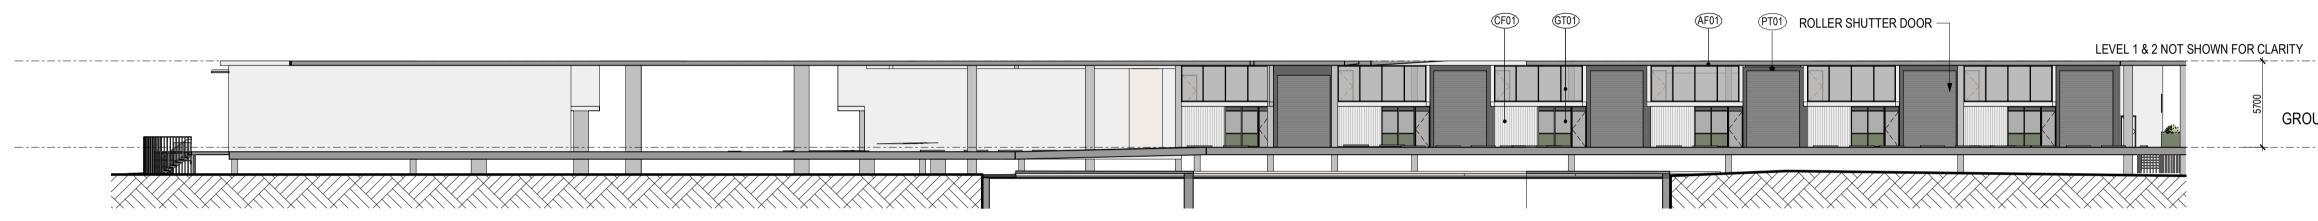
# **DEVELOPMENT APPLICATION**

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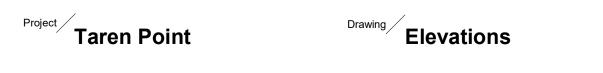
Revisions - 29.09.21 DA Submission
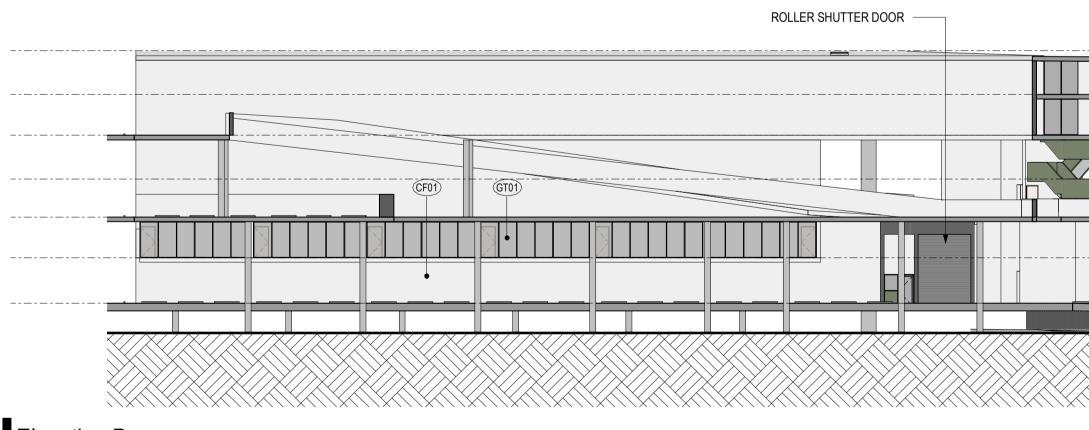
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**Elevation B** 



			ROOF SFL 20.500
	2900	2600	LEVEL 2 MEZ SFL 17.600
	2700	26	LEVEL 2 SFL 14.900
_	2900	00	LEVEL 1 MEZ SFL 12.000
	2500	5400	LEVEL 1 SFL 9.500
	2700	_ 8	GROUND UPPER MEZ
	3000	2700	GROUND UPPER SFL 3.800
	N		

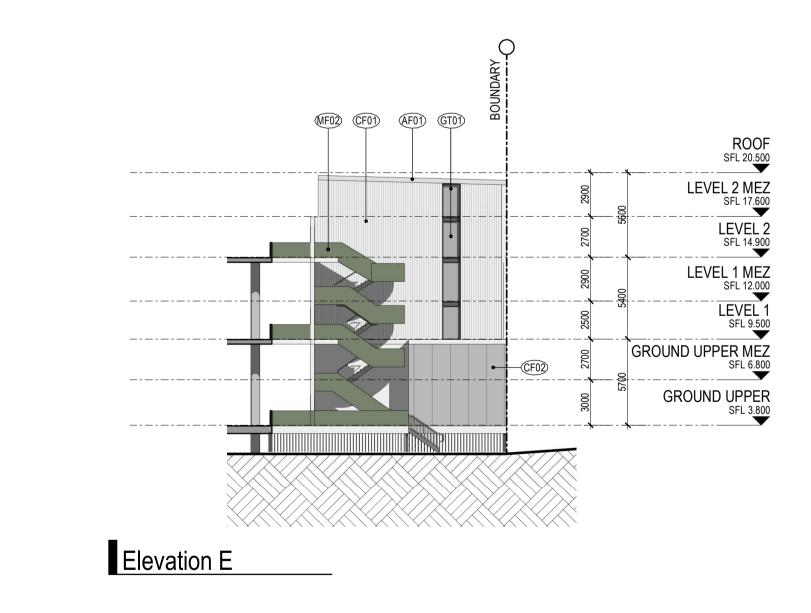

<sup>Date</sup> 29.09.21 Project No <sup>2</sup> 221038

Author JL Scale: @ A1 1:250

72-78 Box Road, Taren Point

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Ð		BOUNDARY			
<u> </u>			4_		ROOF SFL 20.500
			2900	5600	LEVEL 2 MEZ SFL 17.600
			2700	26	LEVEL 2 SFL 14.900
			2900	5400	LEVEL 1 MEZ SFL 12.000
			2500	24	LEVEL 1 SFL 9.500
			3000	000	GROUND MEZ SFL 6.500
			3000	00	GROUND SFL 3.500
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LEVEL 1 SFL 9.500




## LEGEND

CF01 Concrete - Light CF02 Concrete - Grey CS01 Charcoal Coloured Finish CS02 Bronze Coloured Finish AF01 Applied Finish - Light Grey GT01 Glazing Clear





MF01 Charcoal Coloured Finish MF02 Green Coloured Finish PT01 Paint Finish - Charcoal PT02 Paint Finish - Green PT03 Paint Finish - White RF01 Metal Deck Roofing - Light Grey

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JL JL
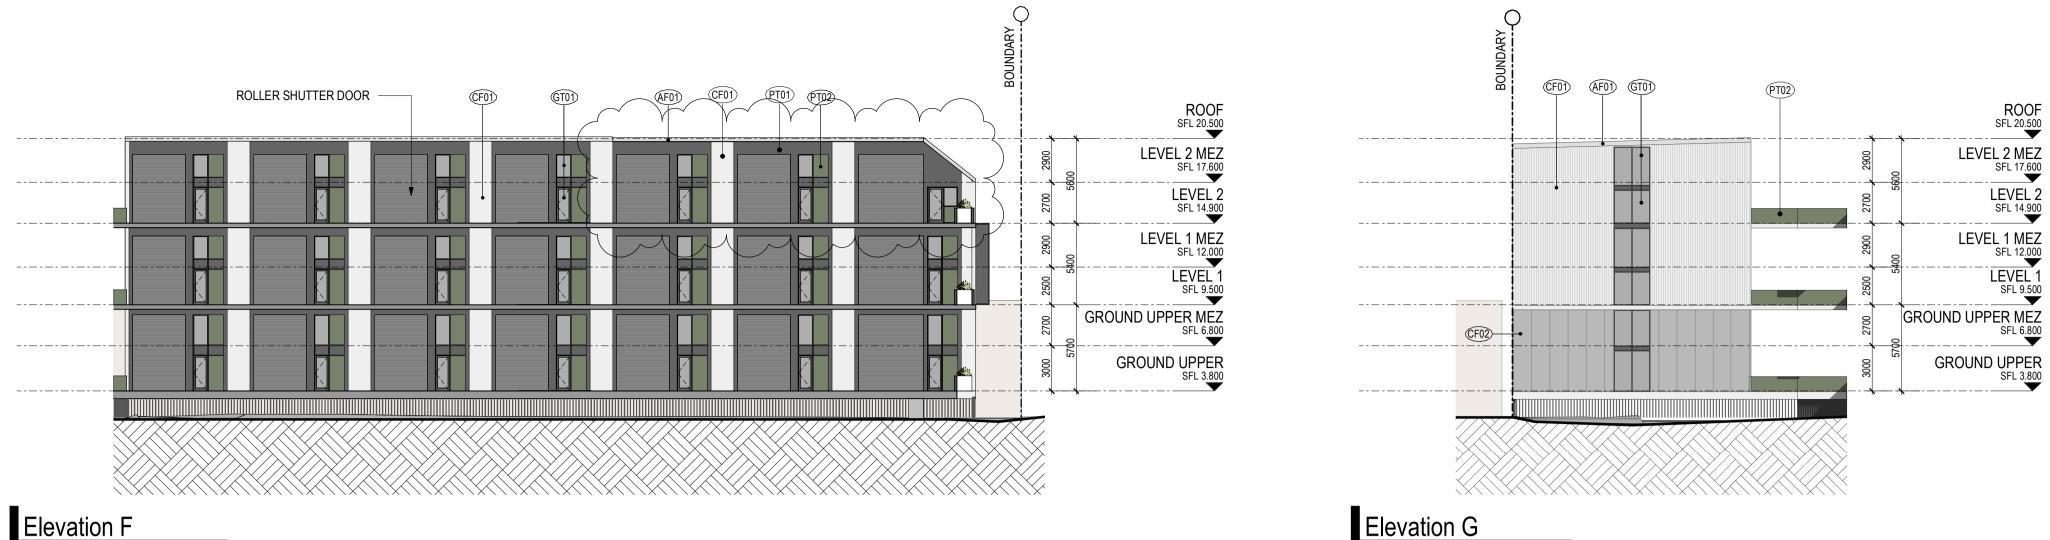
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Drawing Elevations

72-78 Box Road, Taren Point
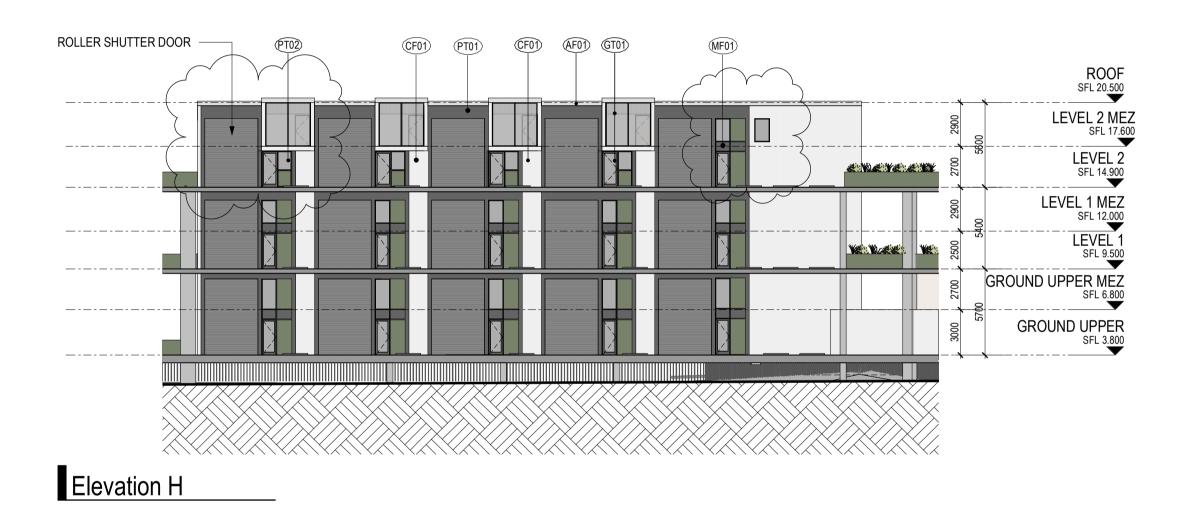
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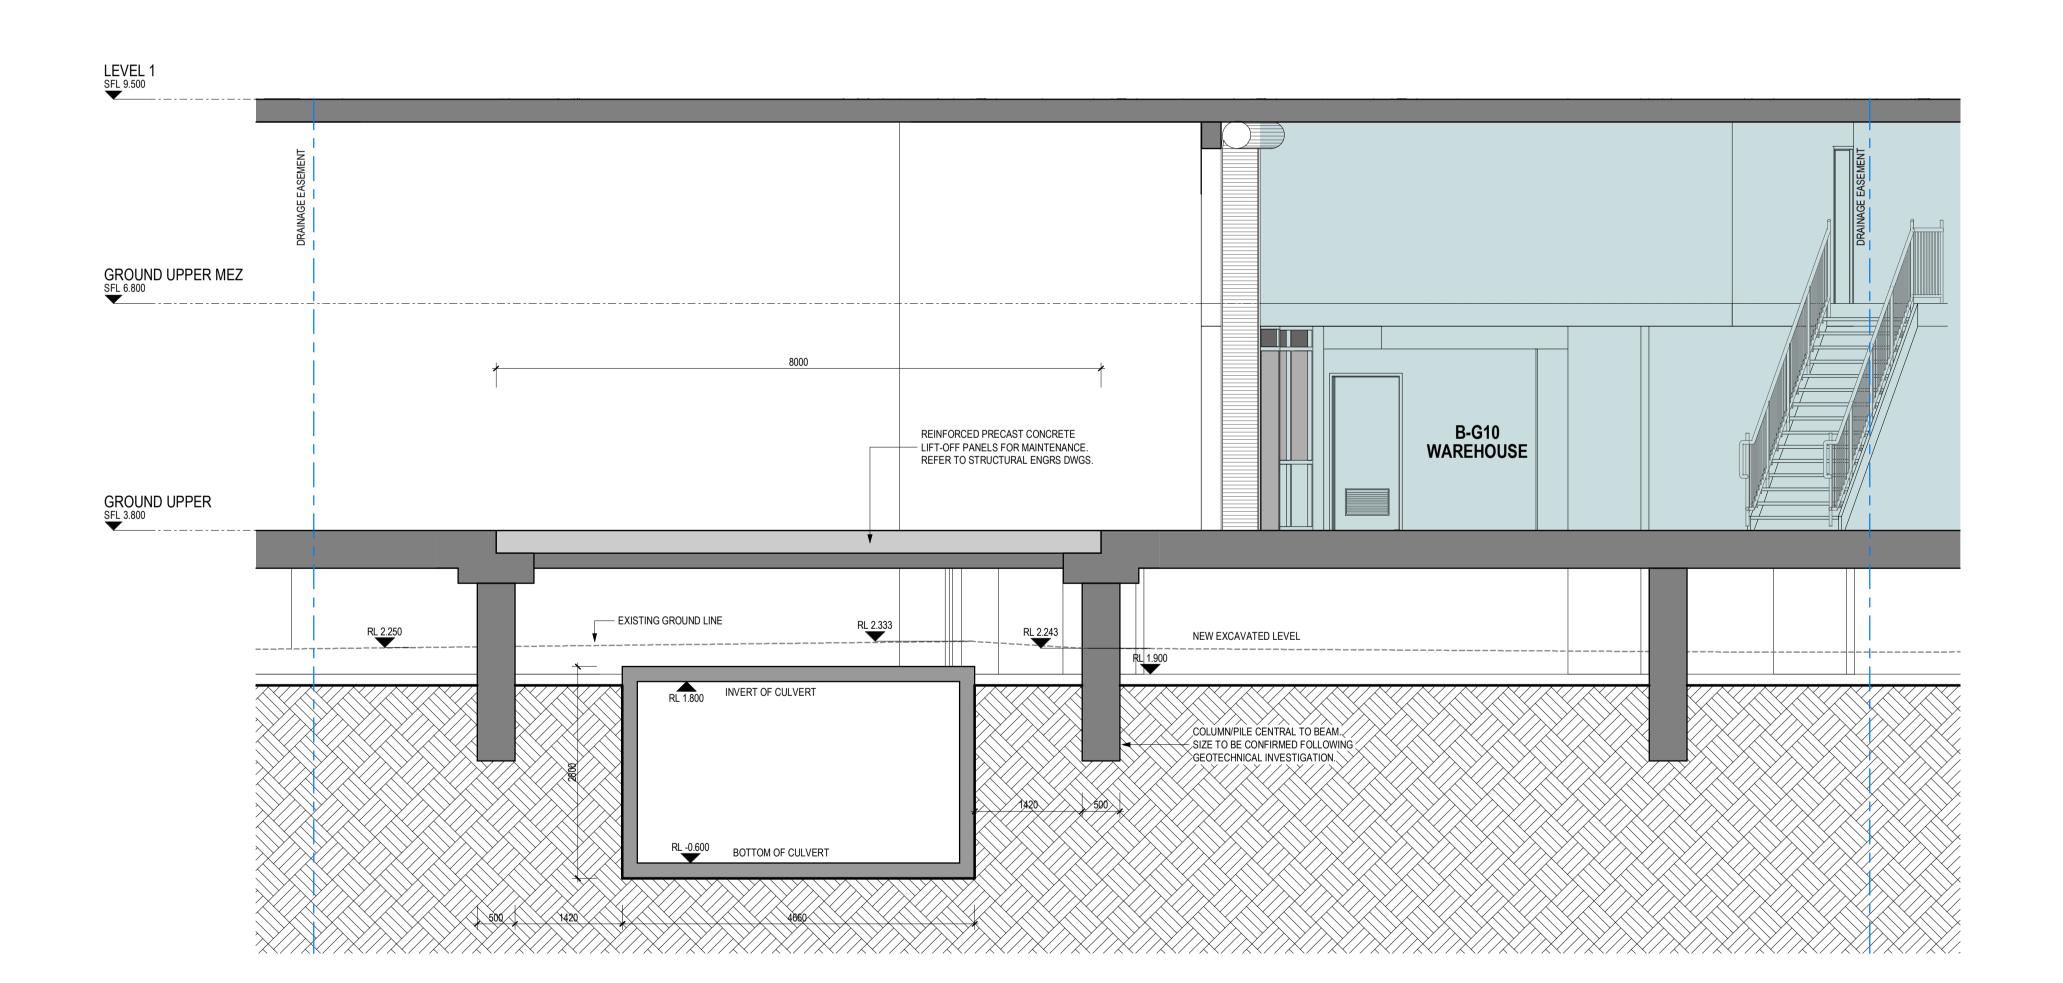
Project No 221038 Date 04.04.22 Author	Scale: @ A1 Dra	awing No. TP02.04 A	rothelowman
		GT01 Glazing Clear	RF01 Metal Deck Roofing - Light Grey
		AF01 Applied Finish - Light Grey	PT03 Paint Finish - White
		CS02 Bronze Coloured Finish	PT02 Paint Finish - Green
		CS01 Charcoal Coloured Finish	PT01 Paint Finish - Charcoal
		CF02 Concrete - Grey	MF02 Green Coloured Finish
SHOWN FOR CLARITY		CF01 Concrete - Light	MF01 Charcoal Coloured Finish
		LEGEND	

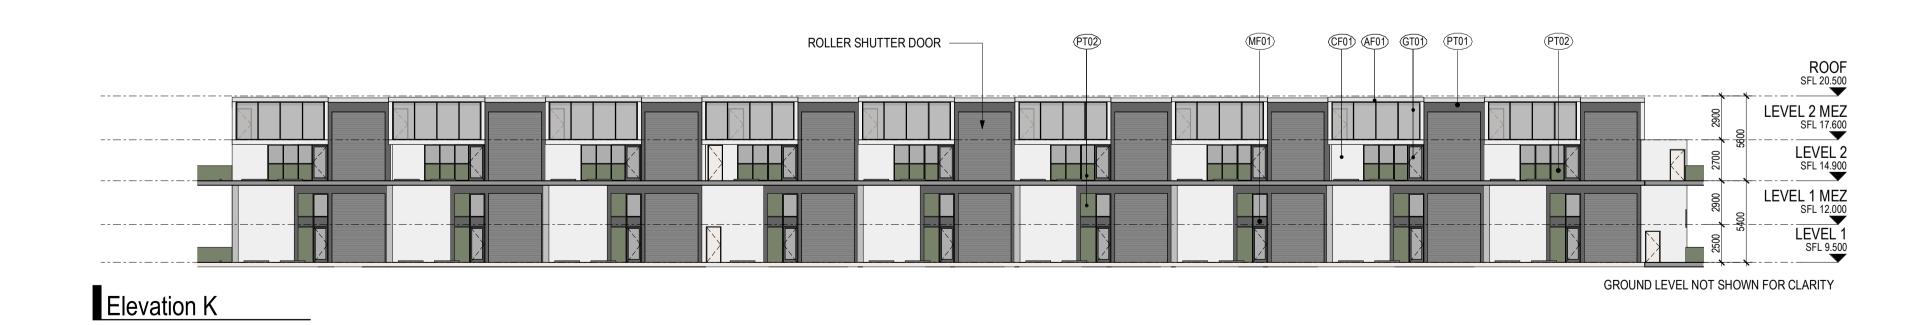



JL JL

Revisions - 29.09.21 DA Submission A 04.04.22 Reponse To Coucil RFIs


2 Culvert Section TP SCALE 1:50



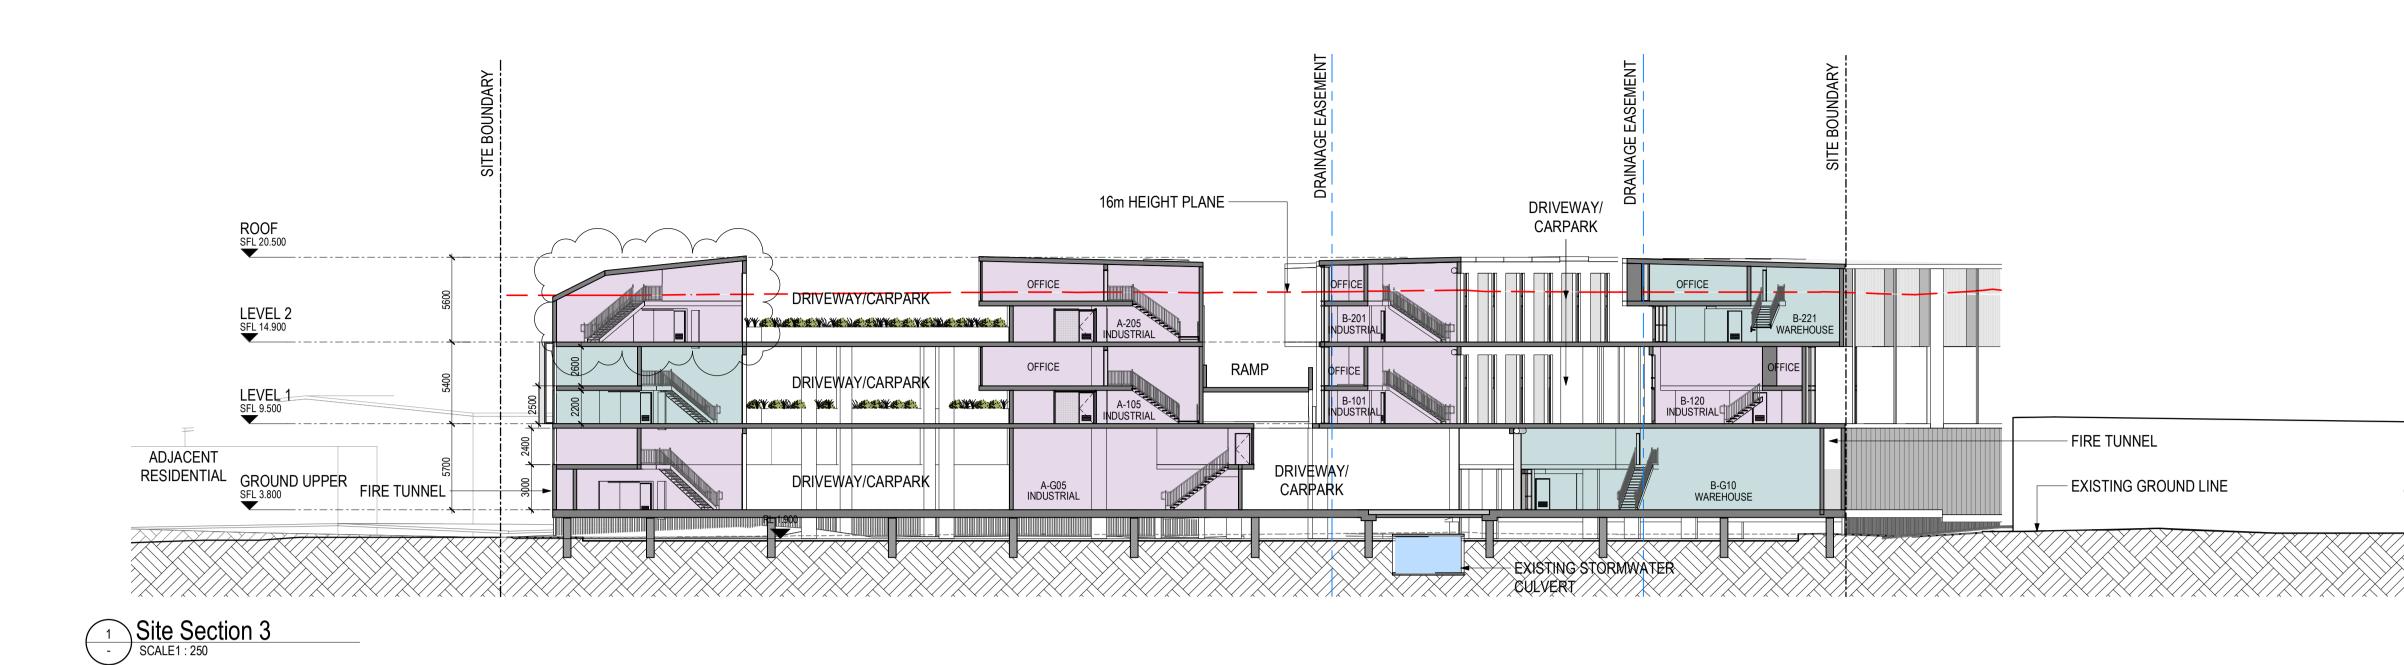

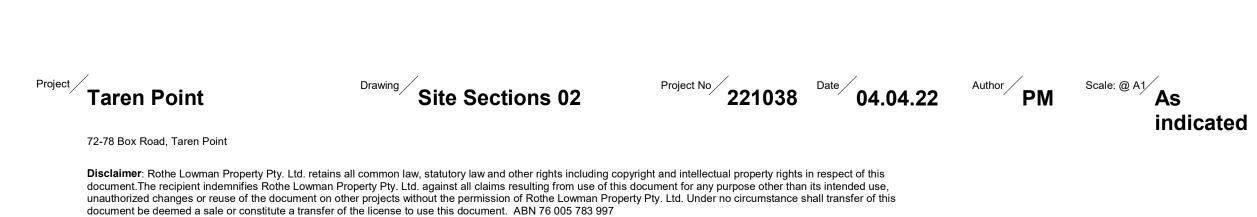

ADJACENT COMMERCIAL

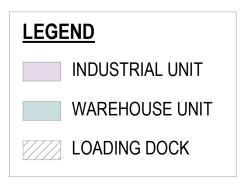





## **DEVELOPMENT APPLICATION** Revisions - 29.09.21 DA Submission


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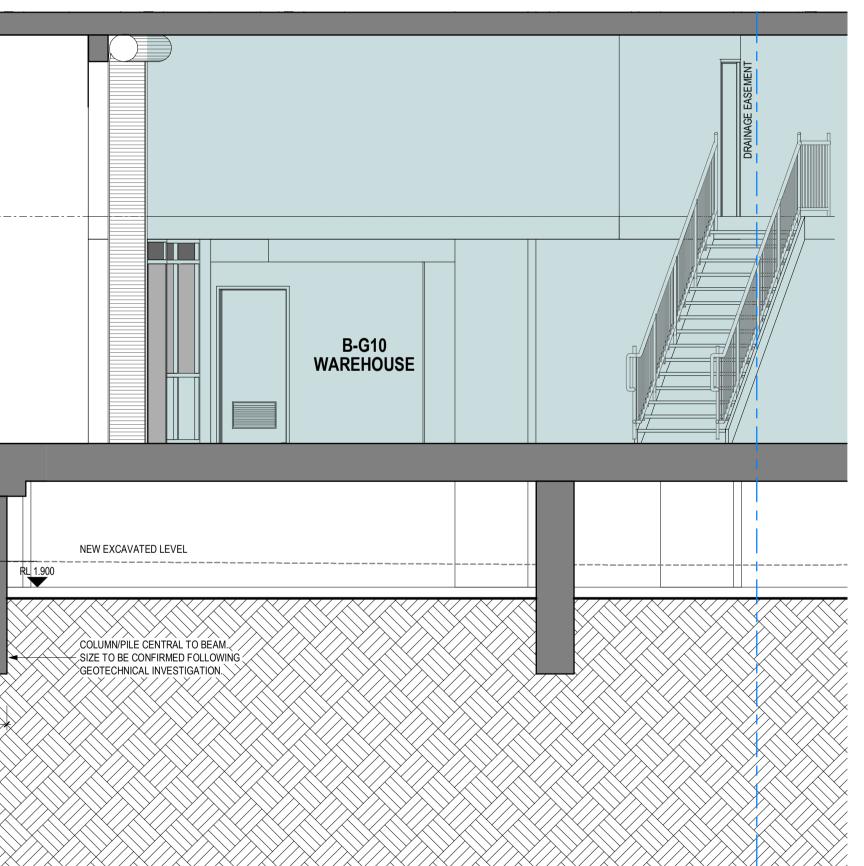
2 Culvert Section TP SCALE 1 : 50

	DRAINAGE EASEMENT			
		   	8000	
				REINFORCED PRECAST CONCRETE LIFT-OFF PANELS FOR MAINTENANCE. REFER TO STRUCTURAL ENGRS DWGS.
GROUND UPPER SFL 3.800			<b>▼</b>	
		RL 2.250	EXISTING GROUND LINE RL 2.333	RL 2.243
			RL-0.600 BOTTOM OF CULVERT	1420 500
		5		

1 Site Section 3 - SCALE1 : 250

LEVEL 1 SFL 9.500



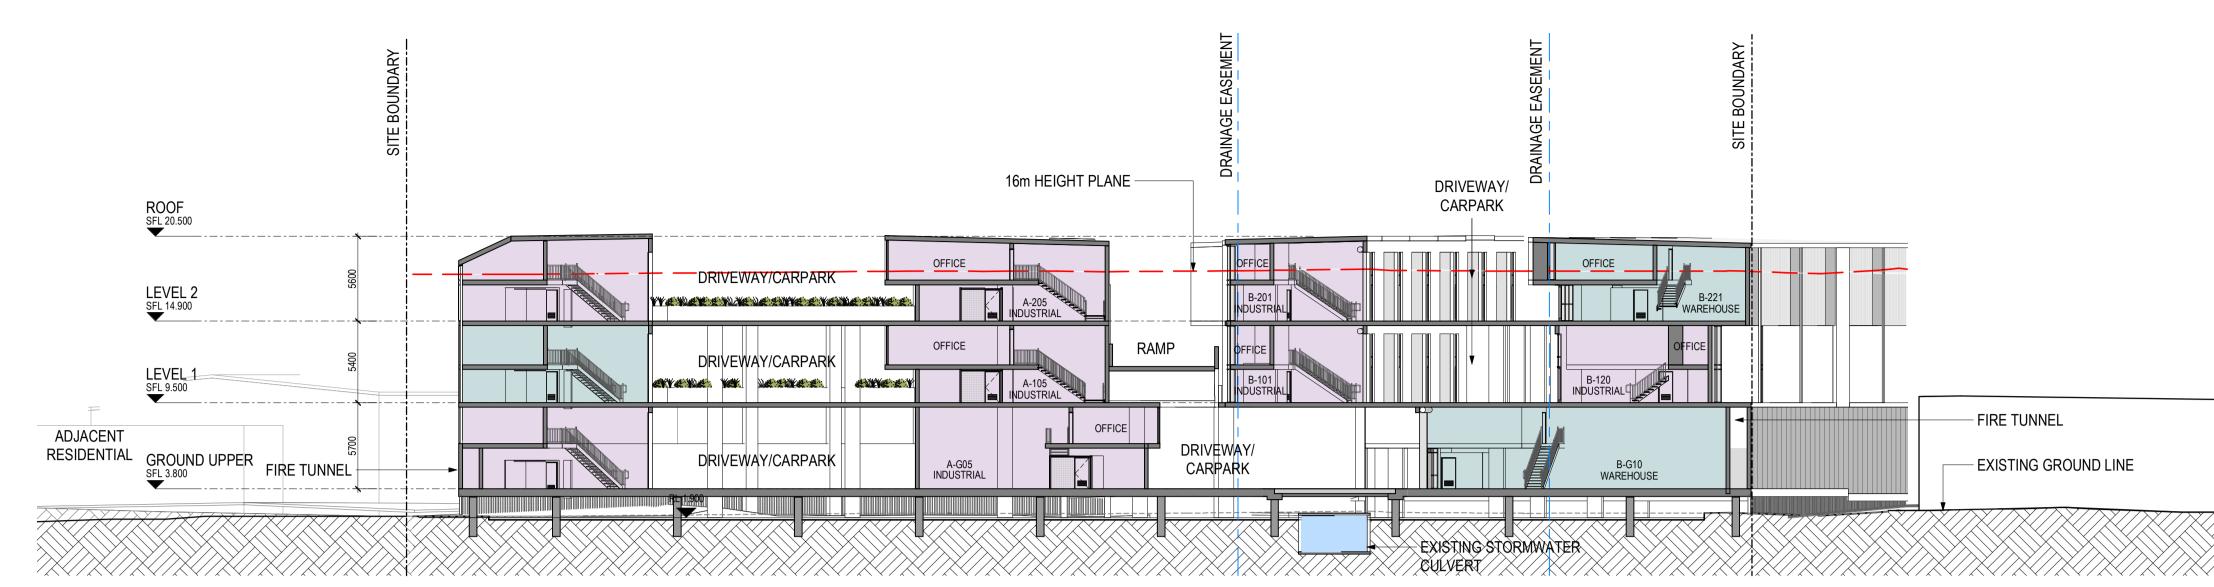



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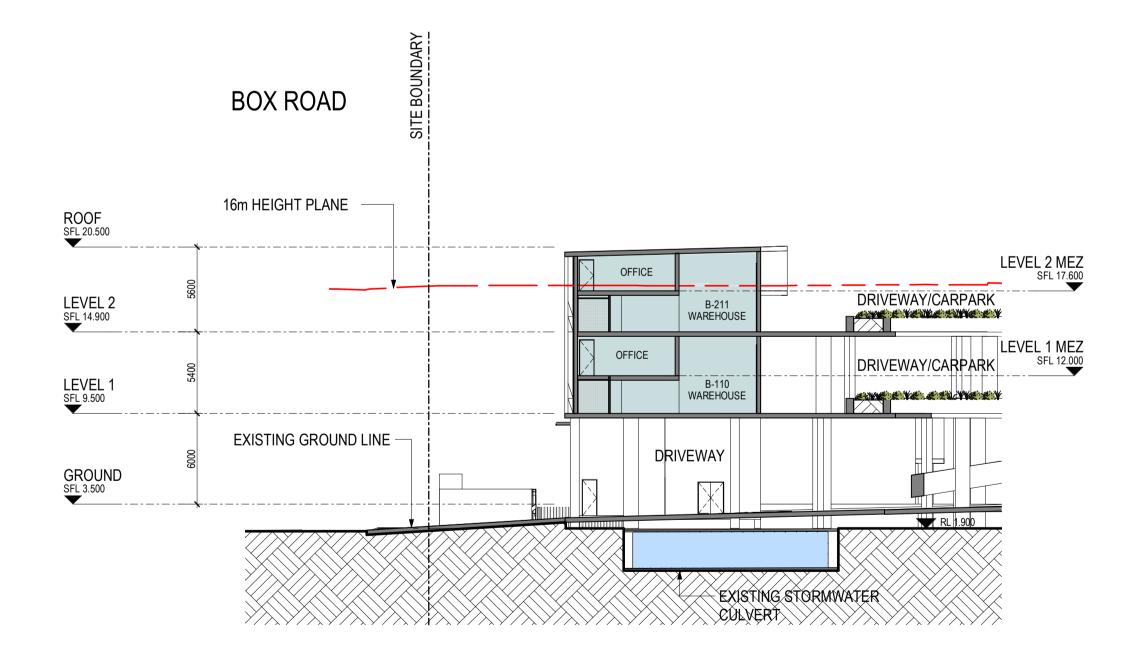
 DEVELOPMENT APPLICATION

 Revisions


 29.09.21 DA Submission


 1
 Site Section 6

 SCALE1:250






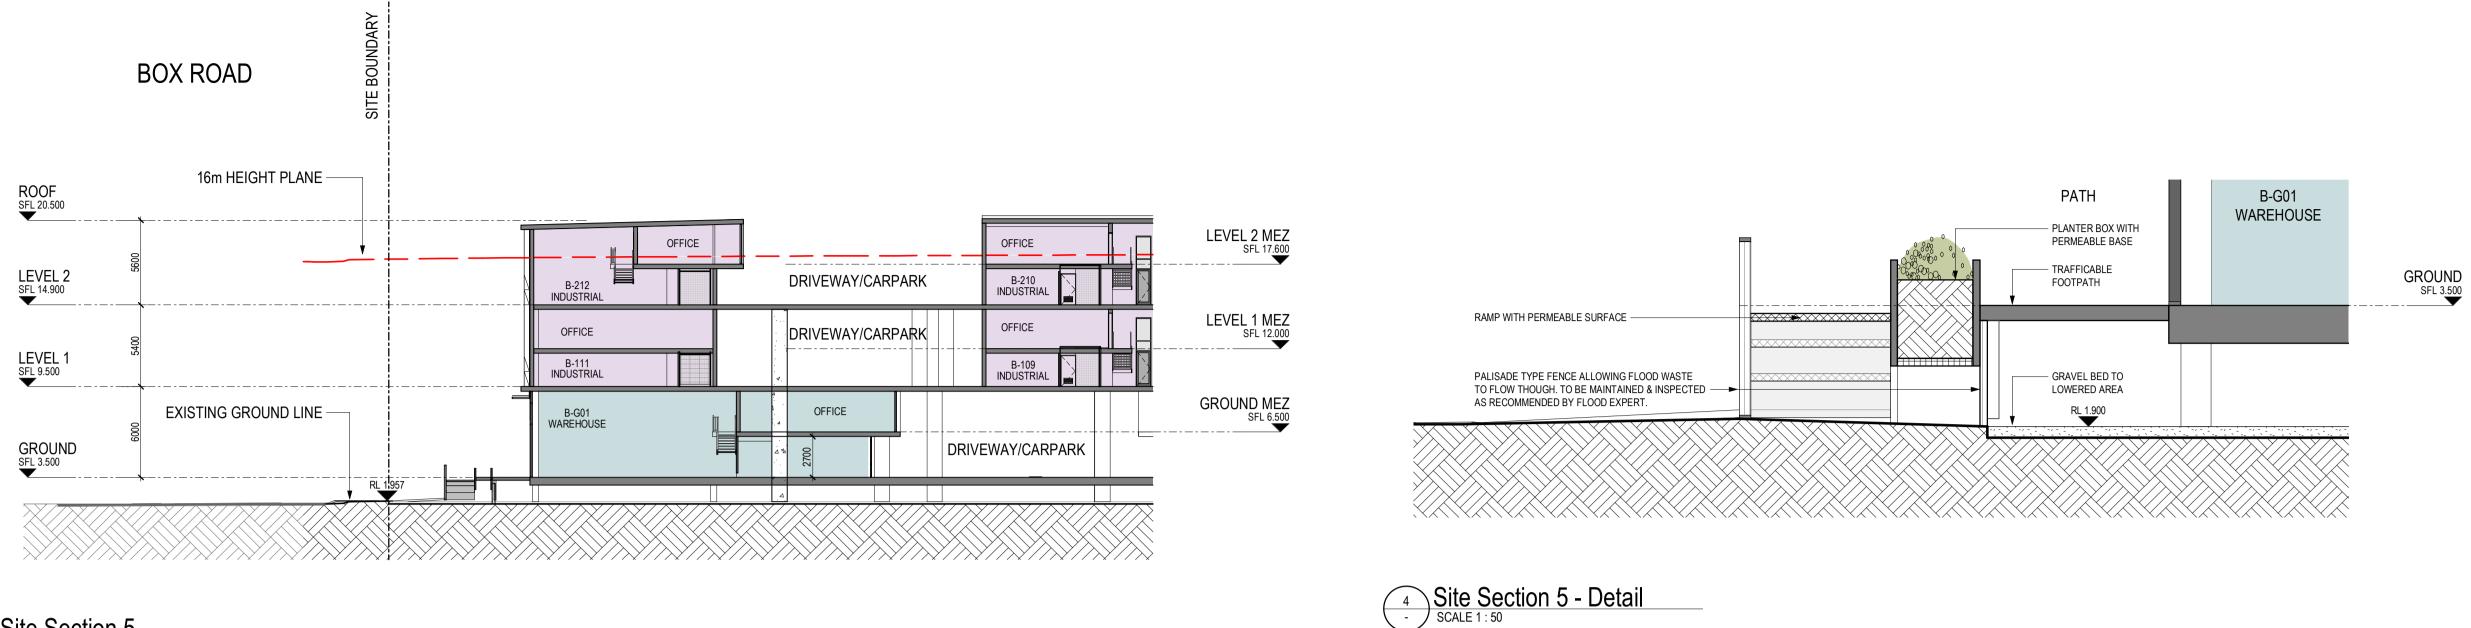

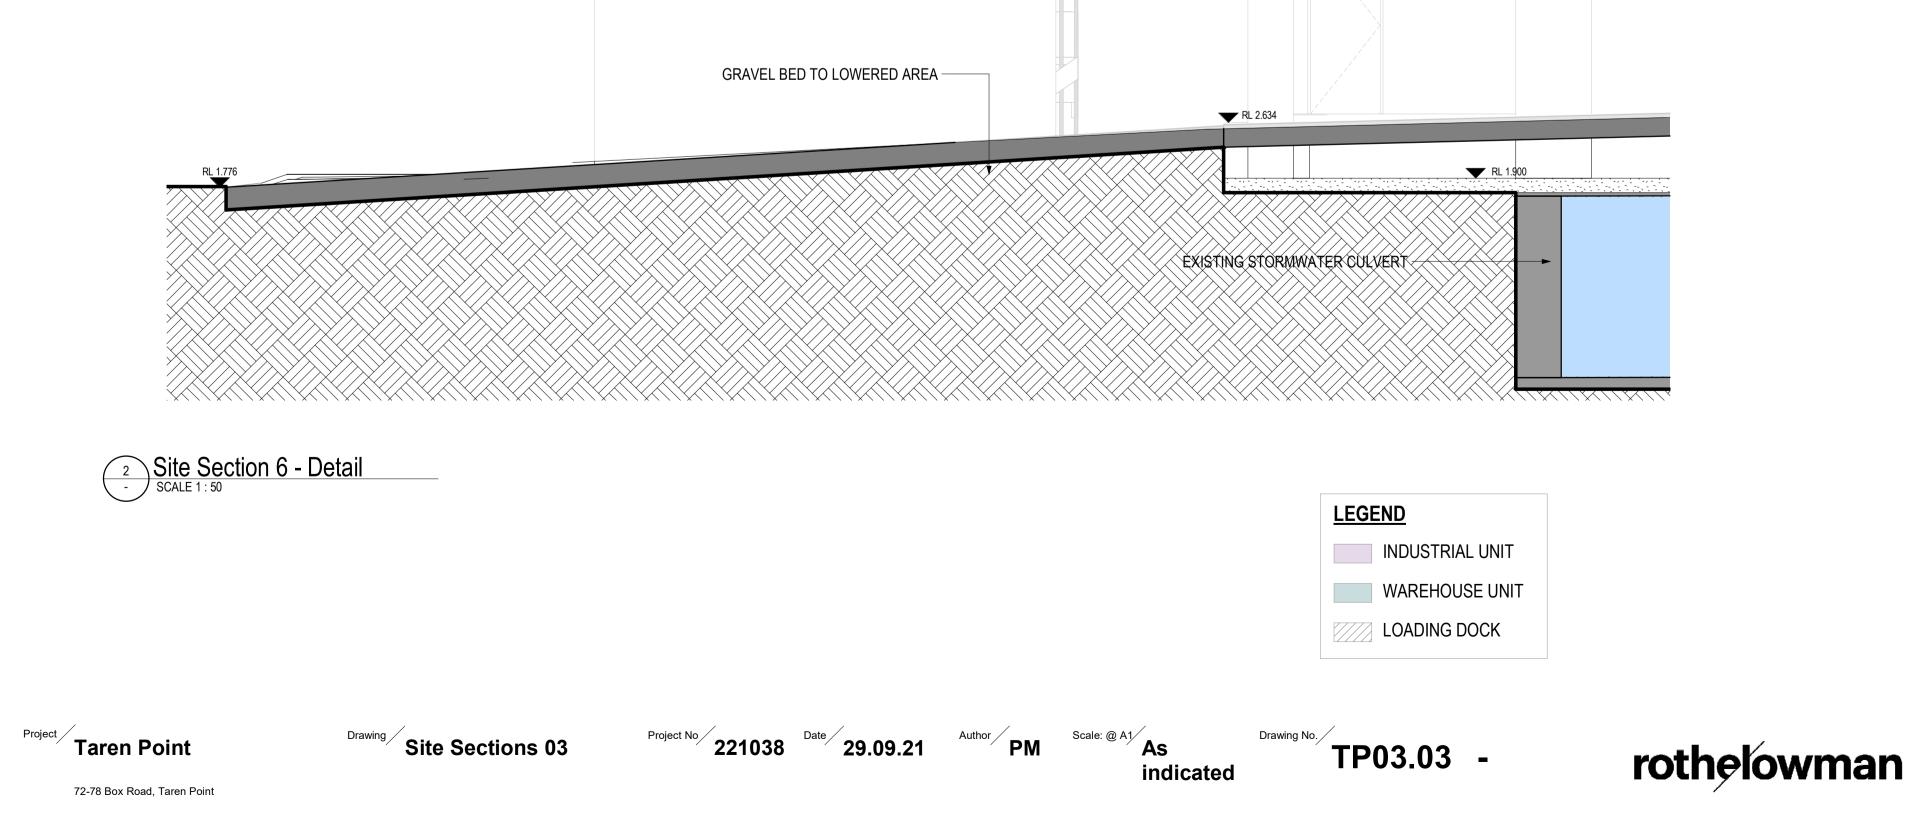

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1 Ramp Section 1 TP01.03 SCALE 1 : 200
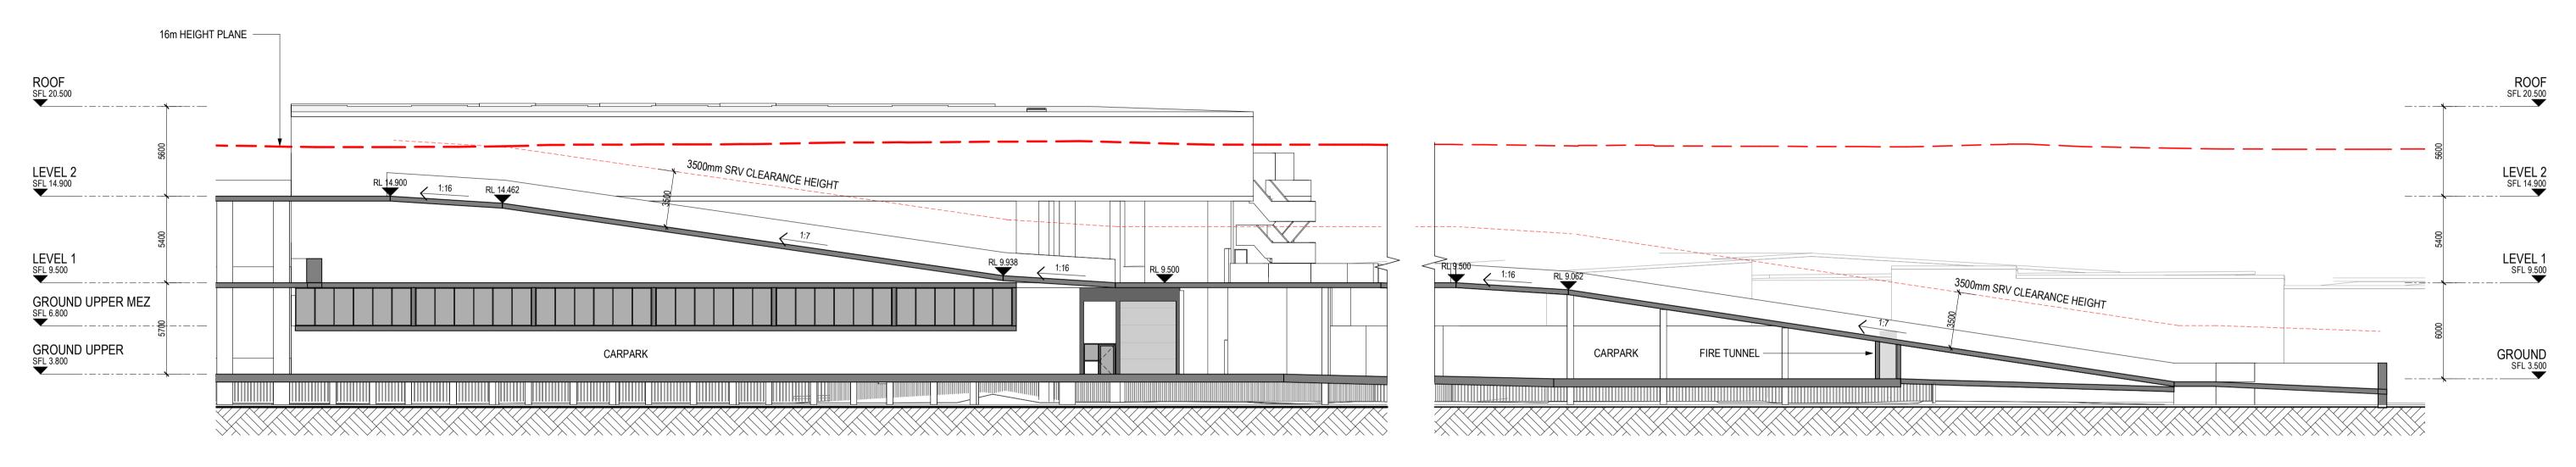
# **DEVELOPMENT APPLICATION**

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30/09/2021 12:09:18 PM


2 TP01.01 Ramp Section 2 SCALE 1: 200

Taren Point


Drawing Ramp Section

72-78 Box Road, Taren Point

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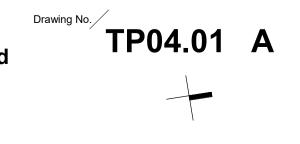


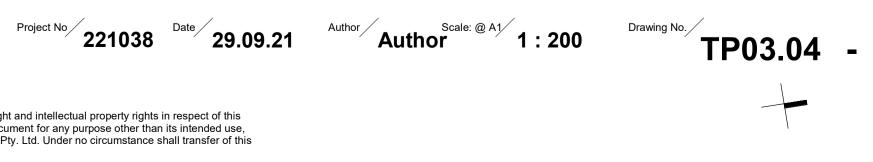Revisions - 29.09.21 DA Submission A 04.04.22 Reponse To Coucil RFIs

4/04/2022 11:28:05 AM
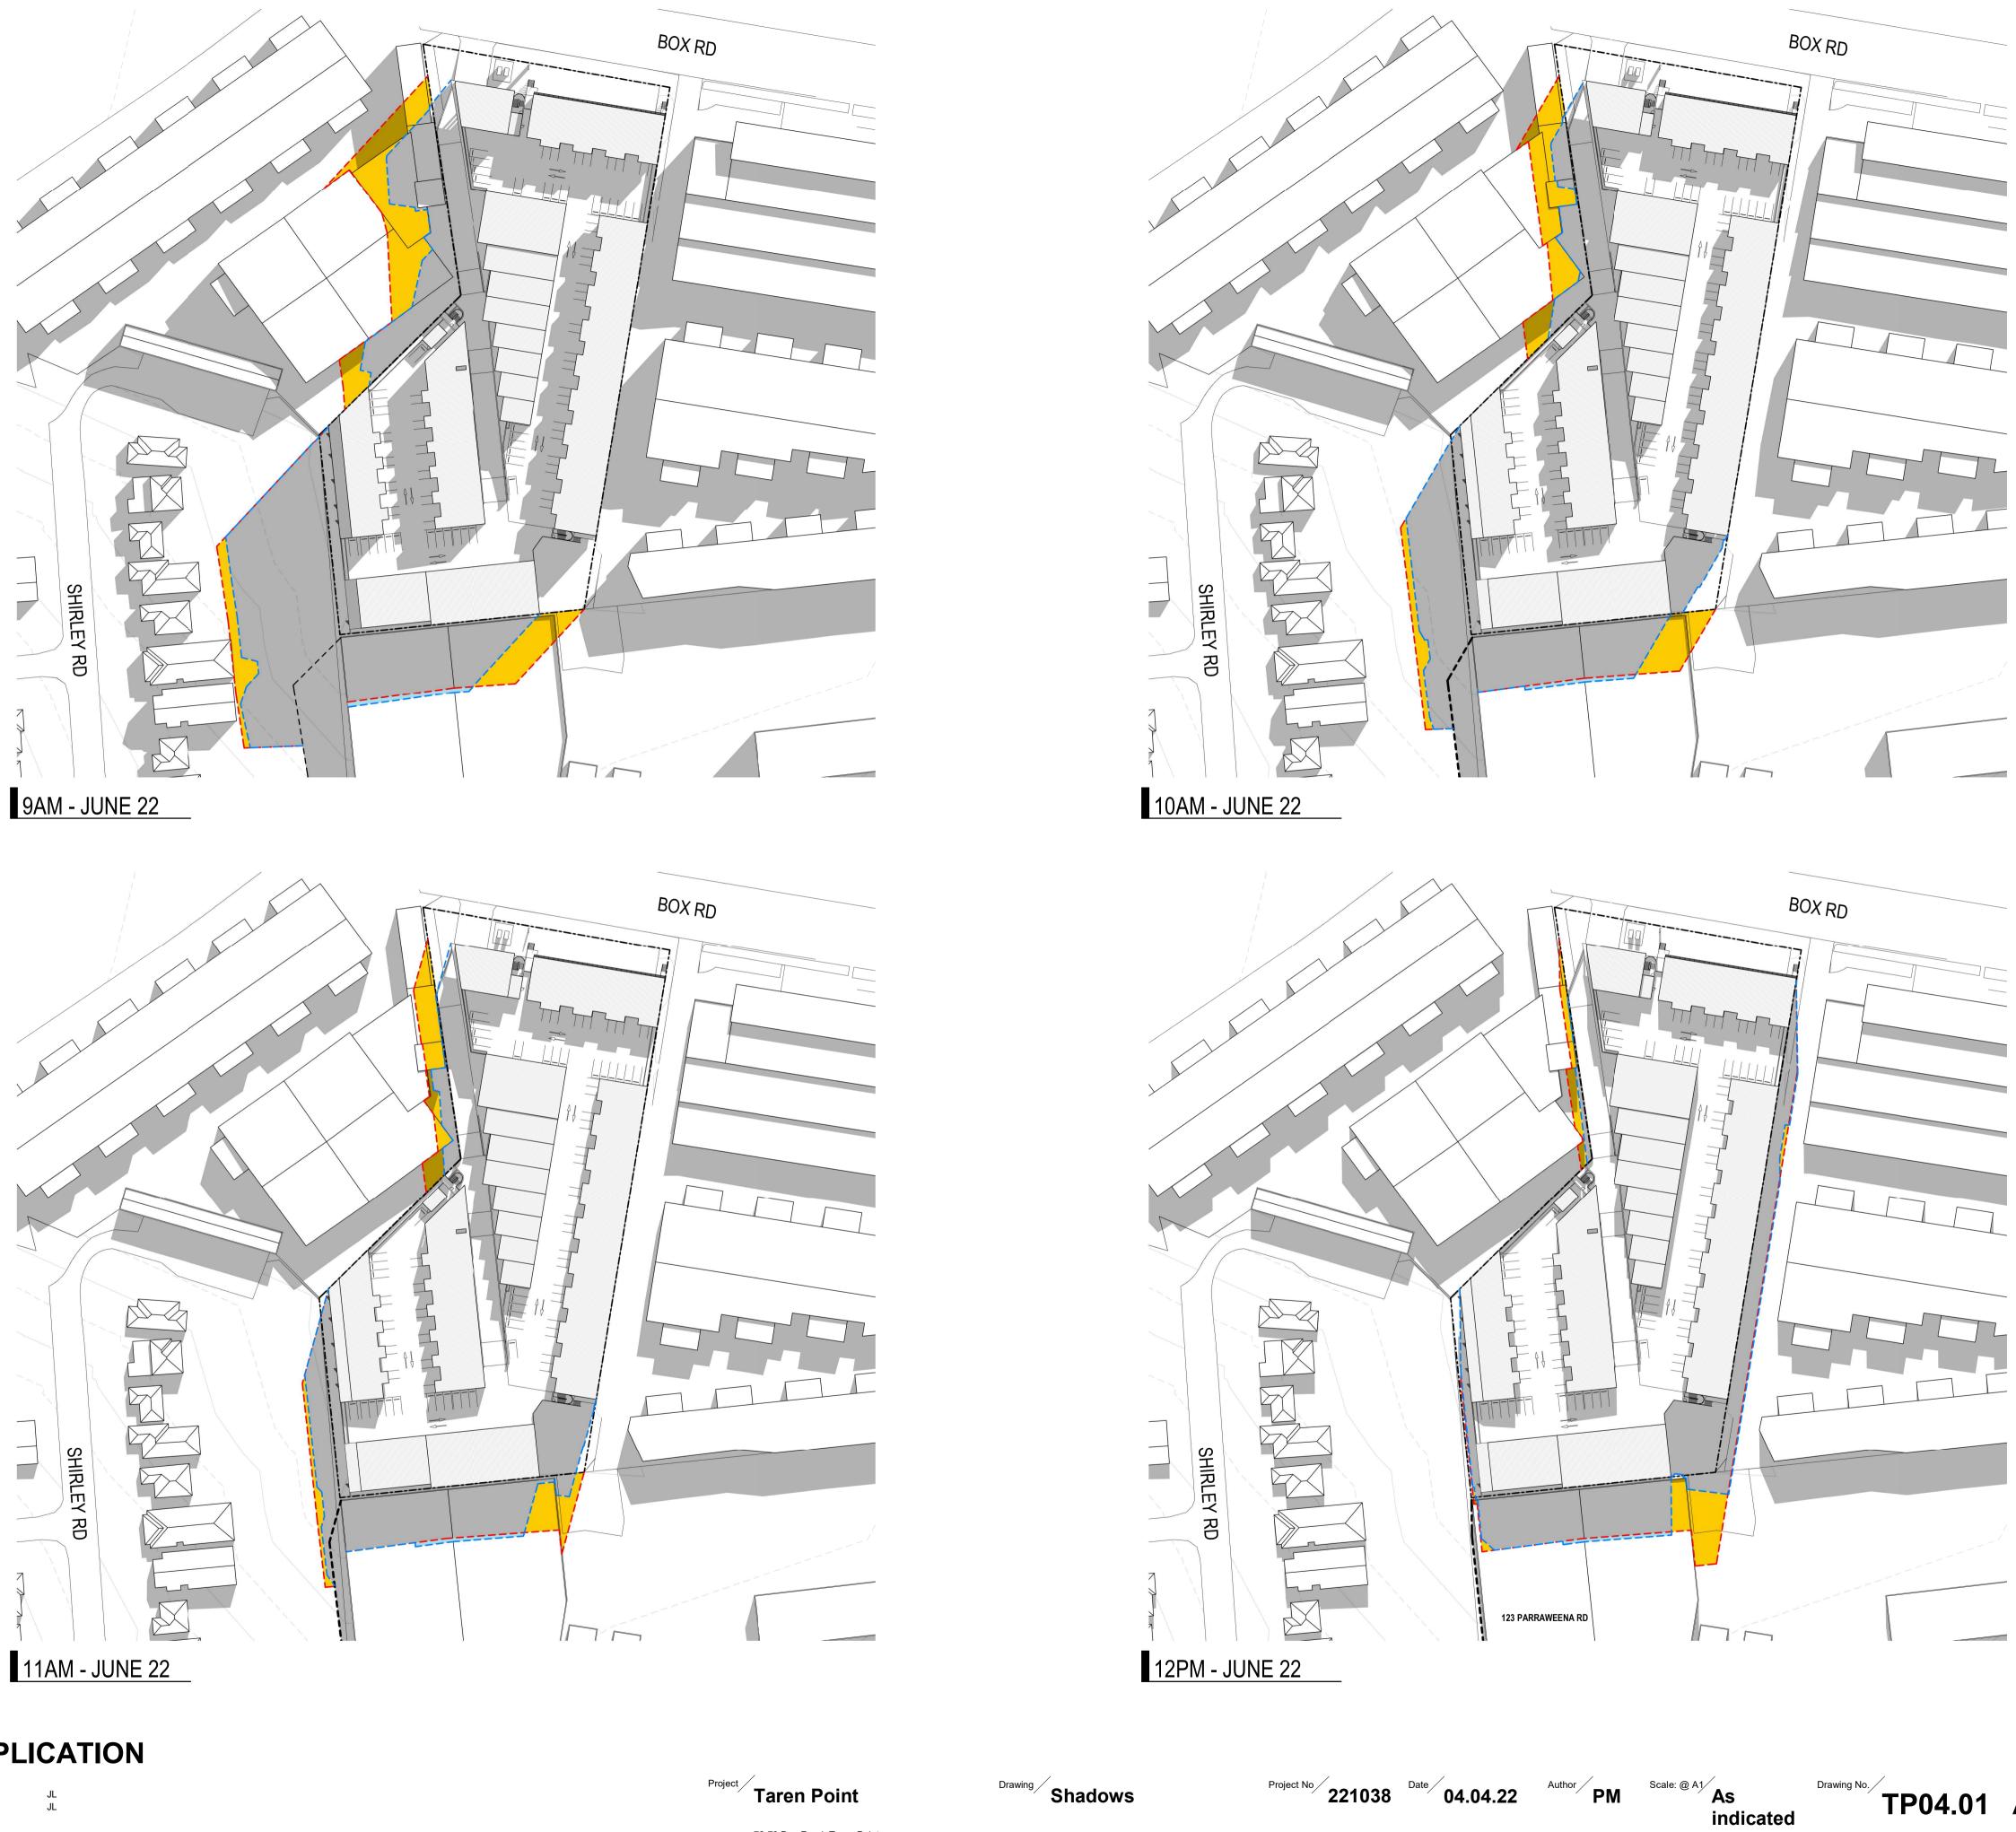
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## **LEGEND**

– – – – – EXISTING SHADOW CAST - NO ADDITIONAL
IMPACTS IN THIS AREA
COMPLIANT DCP ENVELOPE SHADOW LINE
PROPOSED SHADOW LINE
AREA OF SHADOW CAST REDUCED BETWEEN
DCP & PROPOSED ENVELOPE

DCP & PROPOSED ENVELOPE ADDITIONAL SHADOW CAST DIFFERENCE BETWEEN DCP & PROPOSED ENVELOPE





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4/04/2022 11:28:24 AM



2PM - JUNE 22

Project Taren Point

72-78 Box Road, Taren Point

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Project No

Drawing Shadows

, 221038 Date 04.04.22


Author PM Scale: @ A1 As indicated

Drawing No. TP04.02 A

## **LEGEND**

EXISTING SHADOW CAST - NO ADDITIONAL IMPACTS IN THIS AREA
COMPLIANT DCP ENVELOPE SHADOW LINE
PROPOSED SHADOW LINE
AREA OF SHADOW CAST REDUCED BETWEEN DCP & PROPOSED ENVELOPE
ADDITIONAL SHADOW CAST DIFFERENCE BETWEEN DCP & PROPOSED ENVELOPE



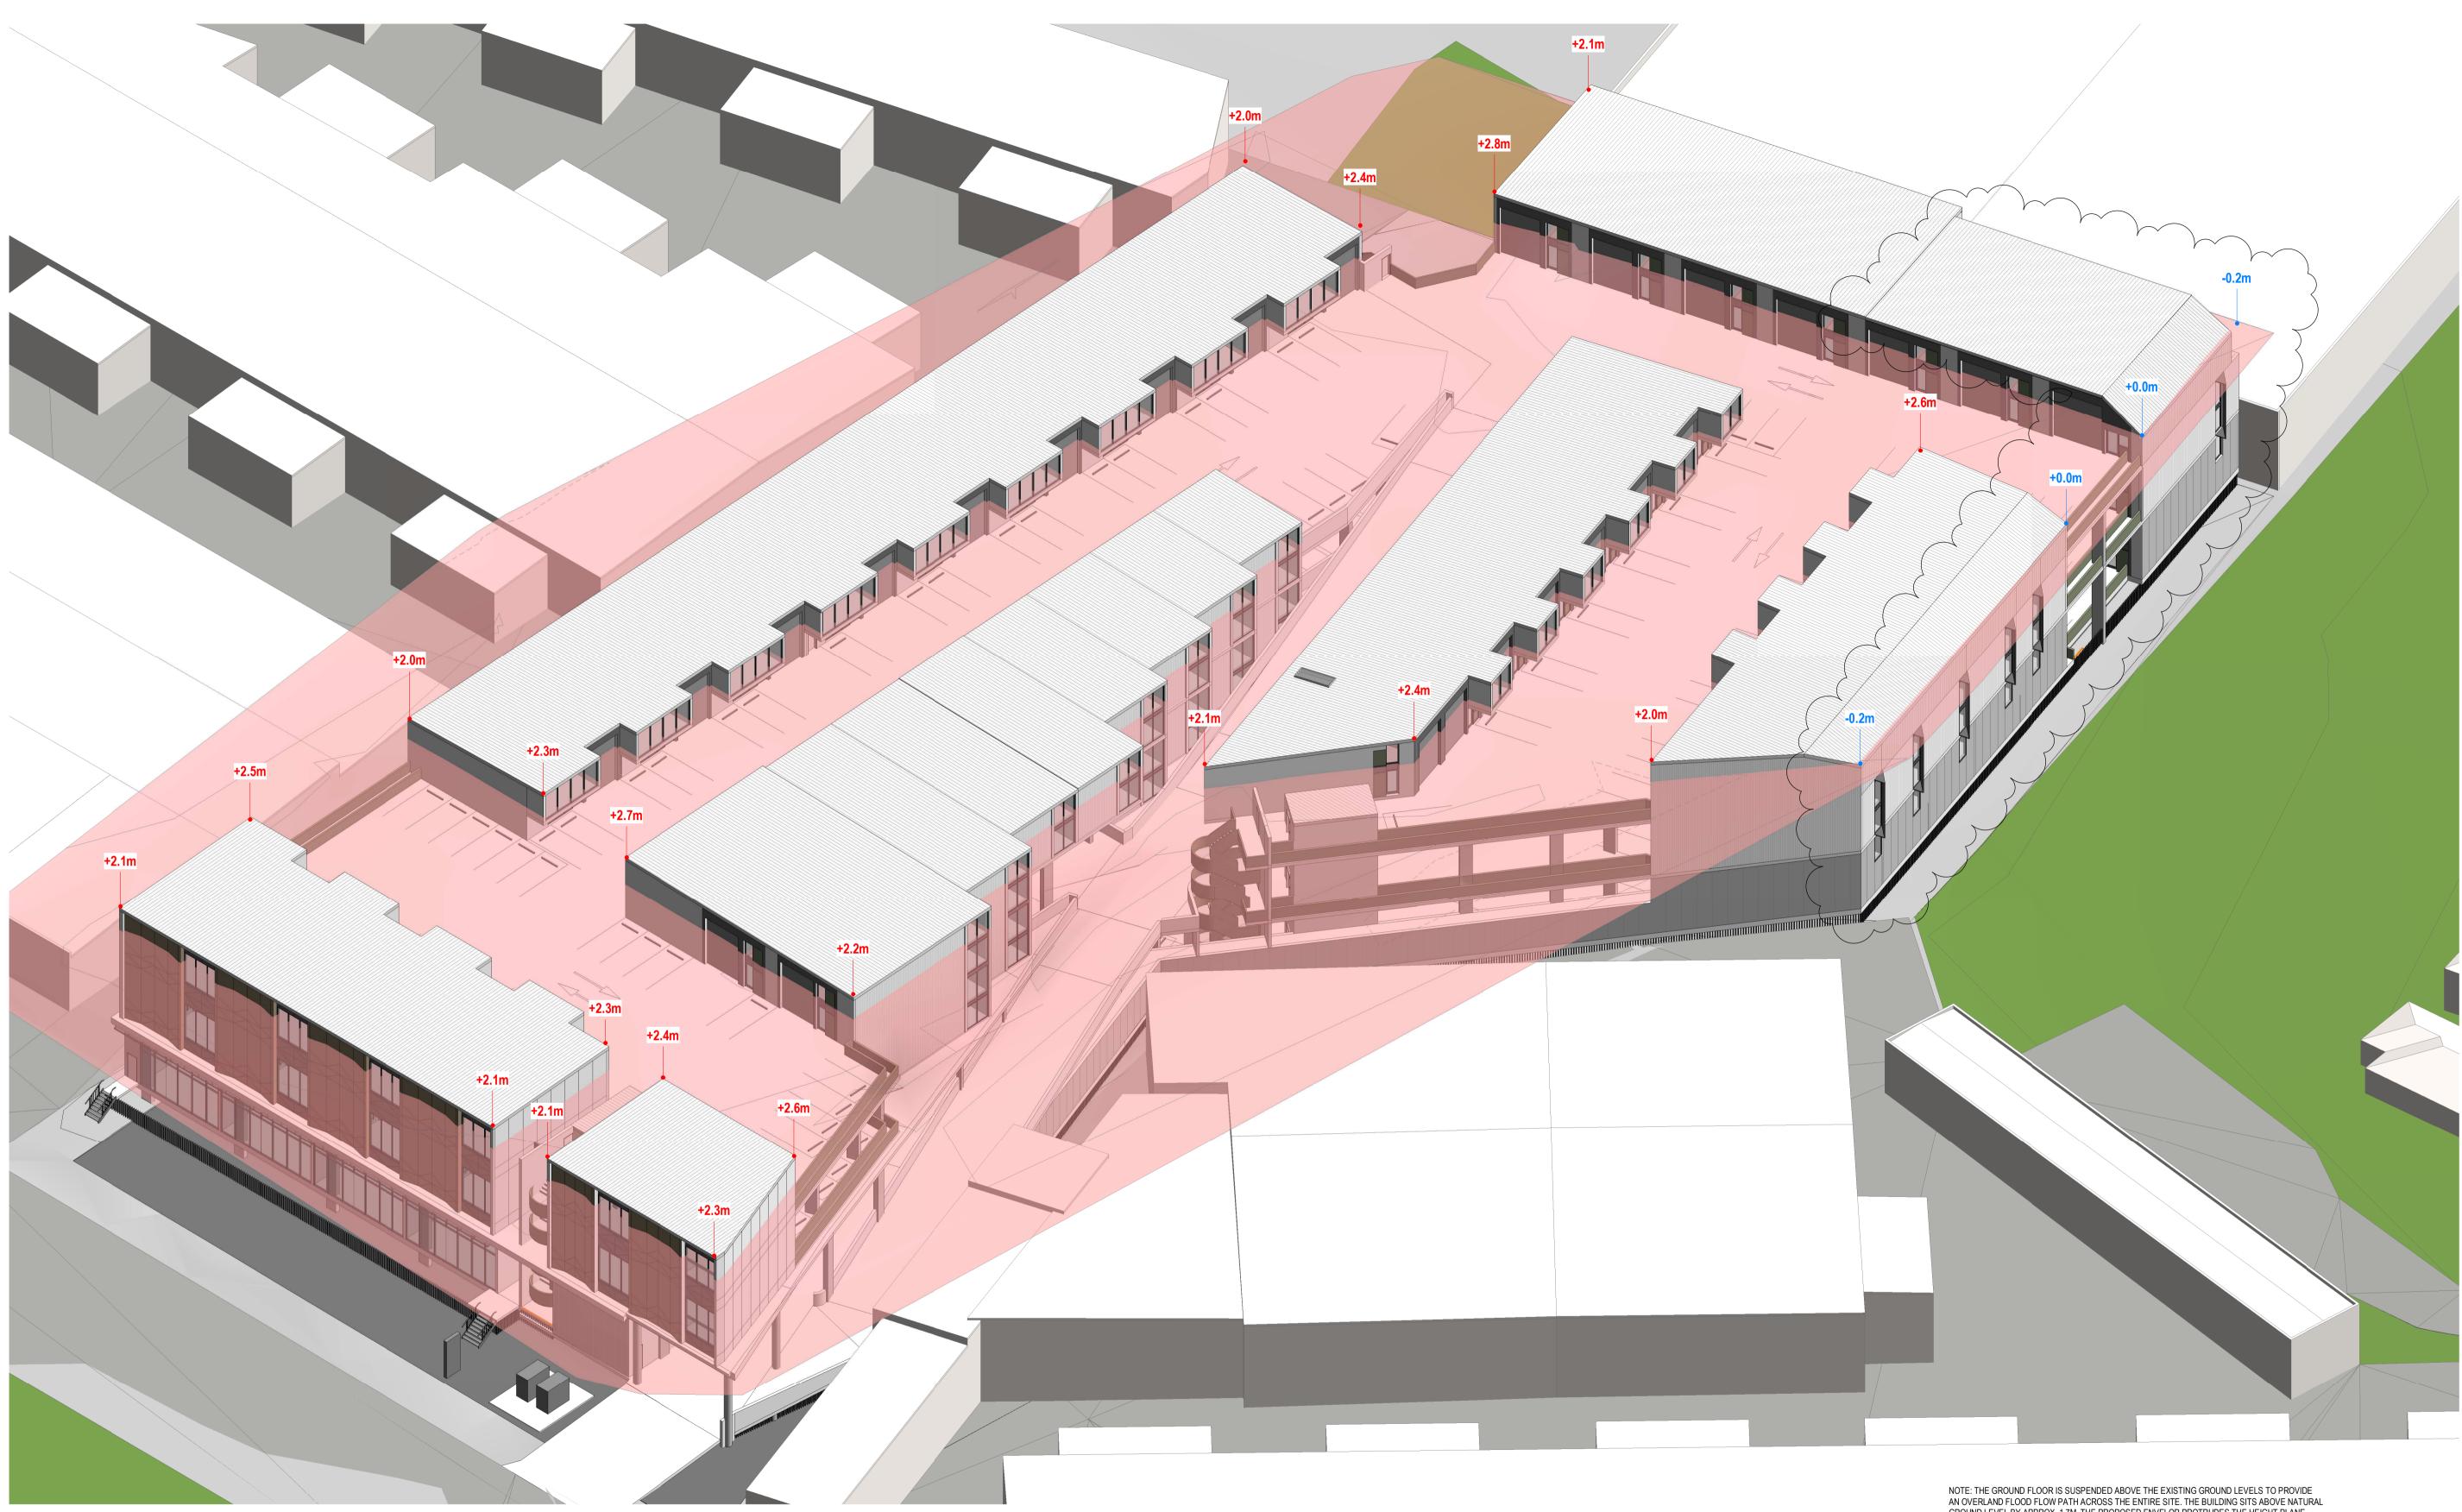

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Revisions - 29.09.21 DA Submission A 04.04.22 Reponse To Coucil RFIs

## 4/04/2022 11:28:39 AM

Plans - PPSSSH-104 (17 May 2022) - DA21/1131

Project Taren Point


 Drawing
 Height Encroachment
 Project No
 221038
 Date
 04.04.22

Author Scale: @ A1

72-78 Box Road, Taren Point

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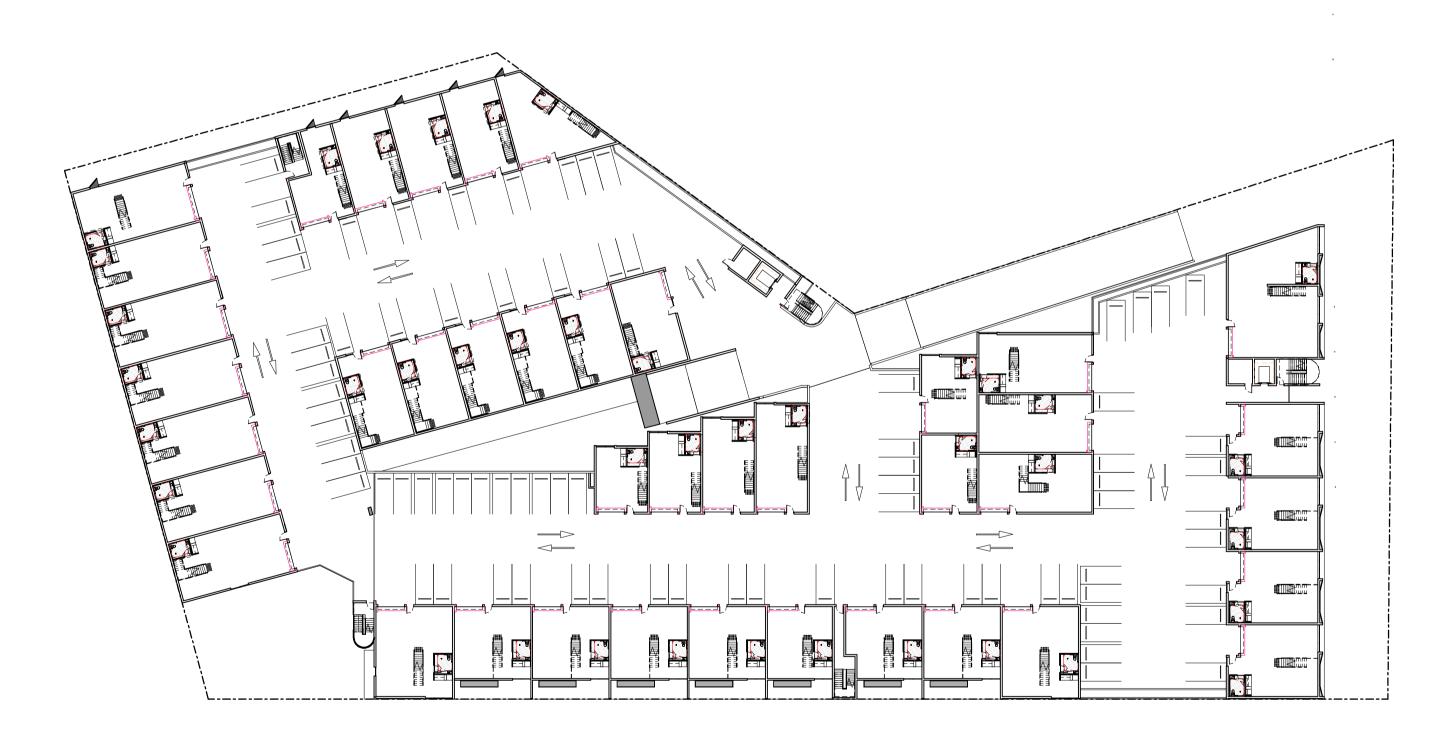
NOTE: THE GROUND FLOOR IS SUSPENDED ABOVE THE EXISTING GROUND LEVELS TO PROVIDE AN OVERLAND FLOOD FLOW PATH ACROSS THE ENTIRE SITE. THE BUILDING SITS ABOVE NATURAL GROUND LEVEL BY APPROX. 1.7M. THE PROPOSED ENVELOP PROTRUDES THE HEIGHT PLANE PROPORTIONALITY. A HEIGHT OF BUILDING ANALYSIS DEMONSTRATES THE PROTRUSIONS ALONG THE BOUNDARY WALLS WITH NO ADVERSE IMPACTS TO NEIGHBORING DEVELOPMENTS



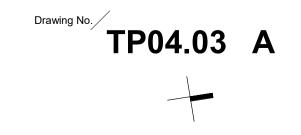








2 LEVEL 1 SK03.01 SCALE 1 : 500

# **DEVELOPMENT APPLICATION**

JL JL

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3 LEVEL 2 SK03.01 SCALE 1 : 500

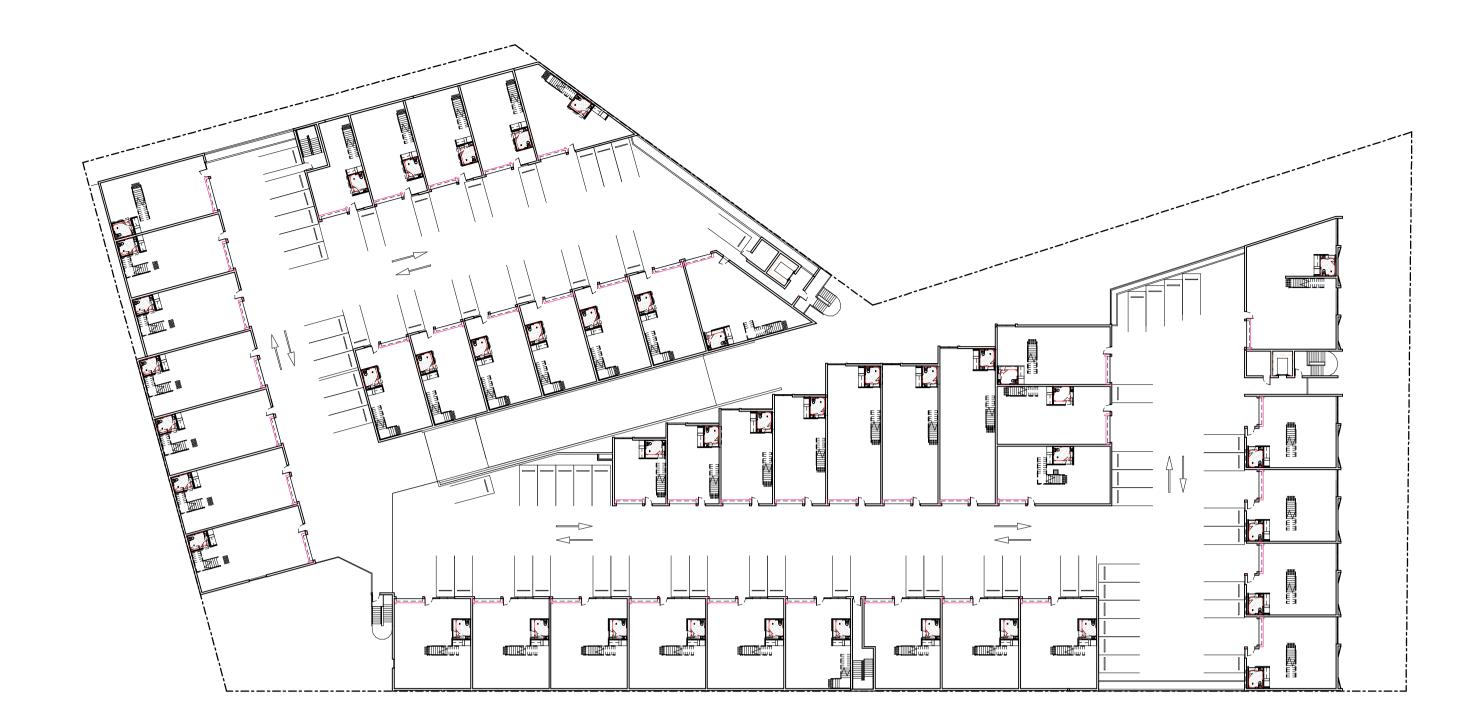LANDSCAPE AREA REQUIREMENT MIN. 10% OF TOTAL SITE AREA (1143.0m<sup>2</sup>)


	Landsca	pe Areas	
$\geq$	Level	Area	
	GROUND	1144.0 m <sup>2</sup>	

# Project Taren Point

72-78 Box Road, Taren Point

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Landscape Plan




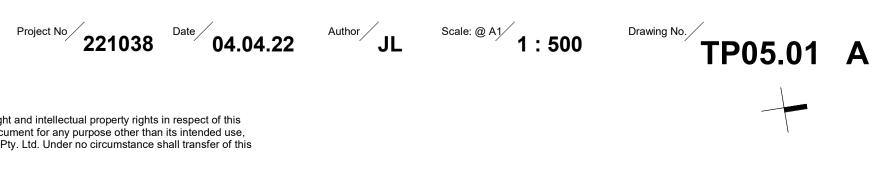








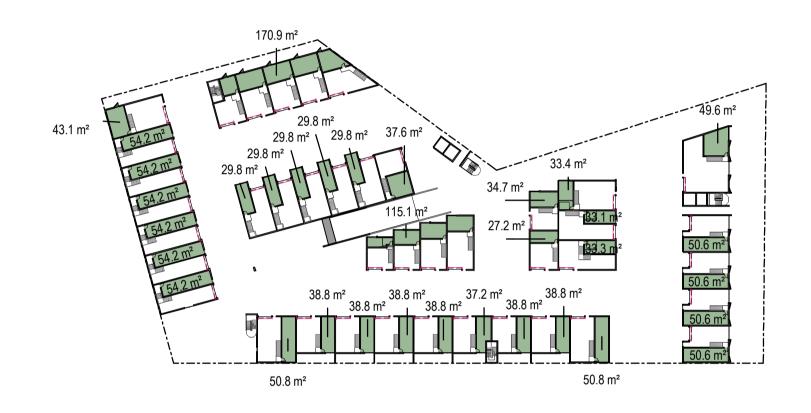

2 Ground Mez - GFA SK03.04 SCALE 1 : 1000

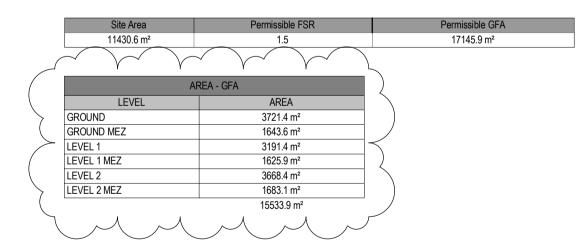

# **DEVELOPMENT APPLICATION**

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4/04/2022 11:32:11 AM

Plans - PPSSSH-104 (17 May 2022) - DA21/1131




3 Level 1 - GFA SK03.01 SCALE 1 : 1000

678.7 m²

4 Level 1 Mez - GFA SK03.03 SCALE 1 : 1000



5 Level 2 - GFA SK03.01 SCALE 1 : 1000

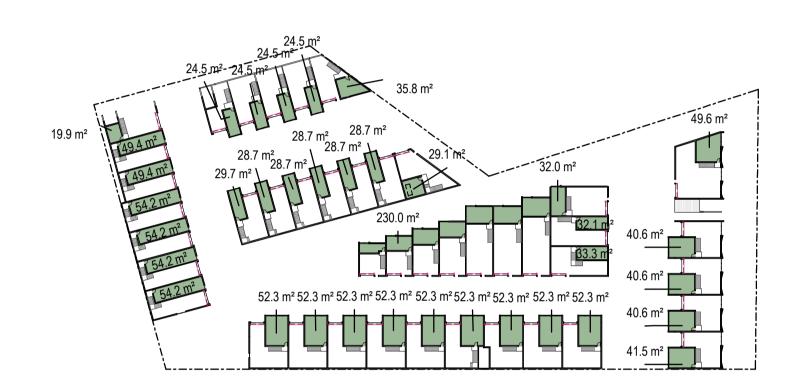


6 Level 2 Mez - GFA SK03.03 SCALE 1 : 1000

Taren Point

72-78 Box Road, Taren Point

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287.8 m²



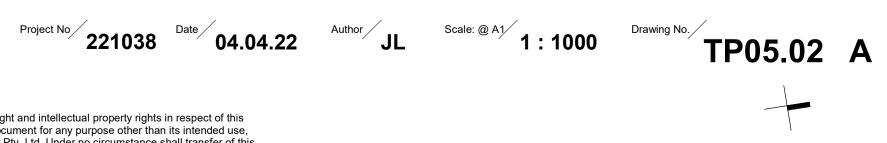

	INDUSTRIAL / WAREHOUSE /	UN		
LEVEL	SHOWROOM	INDUSTRIAL	WAREHOUSE	TOTAL UNITS
GROUND	785.8 m <sup>2</sup>	0	4	4
GROUND UPPER	3546.9 m <sup>2</sup>	14	14	28
GROUND MEZ	369.9 m <sup>2</sup>	0	0	0
GROUND UPPER MEZ	1067.0 m <sup>2</sup>	0	0	0
LEVEL 1	4087.5 m <sup>2</sup>	32	9	41
LEVEL 1 MEZ	1380.4 m <sup>2</sup>	0	0	0
LEVEL 2	4600.9 m <sup>2</sup>	29	14	43
LEVEL 2 MEZ	1459.4 m²	0	0	0
	17297.7 m <sup>2</sup>	75	41	116

# GROUND LEVEL UNITS SCHEDULE

UNIT NUMBER	UNIT TYPE	AREA	UNIT NUMBER	UNIT TYPE	AREA	UNIT NUMBER	UNIT TYPE	AREA	UNIT NUMBER	UNIT T
A-G01			A-G08			A-G15			B-G03	
A-G01	INDUSTRIAL	107.6 m <sup>2</sup>	A-G08	INDUSTRIAL	76.9 m <sup>2</sup>	A-G15	WAREHOUSE	117.9 m <sup>2</sup>	B-G03	WAREH
A-G01	OFFICE	34.6 m <sup>2</sup>	A-G08	OFFICE	29.1 m <sup>2</sup>	A-G15	OFFICE	46.8 m <sup>2</sup>	B-G03	OFFICE
		142.2 m <sup>2</sup>	L	I	106.0 m <sup>2</sup>			164.6 m <sup>2</sup>		
A-G02			A-G09			A-G16			B-G04	
A-G02	INDUSTRIAL	107.6 m <sup>2</sup>	A-G09	INDUSTRIAL	79.0 m <sup>2</sup>	A-G16	WAREHOUSE	117.9 m <sup>2</sup>	B-G04	WAREH
A-G02	OFFICE	34.6 m <sup>2</sup>	A-G09	OFFICE	38.8 m <sup>2</sup>	A-G16	OFFICE	46.9 m <sup>2</sup>	B-G04	OFFICE
		142.2 m <sup>2</sup>		· ·	117.8 m <sup>2</sup>			164.7 m <sup>2</sup>		_
A-G03			A-G10			A-G17			B-G05	
A-G03	INDUSTRIAL	107.6 m <sup>2</sup>	A-G10	INDUSTRIAL	79.0 m <sup>2</sup>	A-G17	WAREHOUSE	117.9 m <sup>2</sup>	B-G05	WAREH
A-G03	OFFICE	34.6 m <sup>2</sup>	A-G10	OFFICE	38.8 m²	A-G17	OFFICE	46.9 m <sup>2</sup>	B-G05	OFFICE
		142.2 m <sup>2</sup>	L		117.8 m <sup>2</sup>			164.7 m <sup>2</sup>		_
A-G04			A-G11			A-G18			B-G06	
A-G04	INDUSTRIAL	107.6 m <sup>2</sup>	A-G11	INDUSTRIAL	79.0 m <sup>2</sup>	A-G18	WAREHOUSE	117.9 m <sup>2</sup>	B-G06	WAREH
A-G04	OFFICE	34.6 m <sup>2</sup>	A-G11	OFFICE	38.8 m²	A-G18	OFFICE	46.9 m²	B-G06	OFFICE
		142.2 m <sup>2</sup>			117.8 m <sup>2</sup>			164.8 m <sup>2</sup>		
A-G05			A-G12			A-G19			B-G07	
A-G05	INDUSTRIAL	107.6 m <sup>2</sup>	A-G12	INDUSTRIAL	65.2 m²	A-G19	WAREHOUSE	117.9 m <sup>2</sup>	B-G07	OFFICE
A-G05	OFFICE	34.6 m <sup>2</sup>	A-G12	OFFICE	21.9 m <sup>2</sup>	A-G19	OFFICE	46.9 m²	B-G07	WAREH
		142.2 m <sup>2</sup>			87.1 m <sup>2</sup>			164.7 m <sup>2</sup>		
A-G06			A-G13			B-G01			B-G08	
A-G06	INDUSTRIAL	107.6 m <sup>2</sup>	A-G13	INDUSTRIAL	118.2 m <sup>2</sup>	B-G01	WAREHOUSE	203.3 m <sup>2</sup>	B-G08	WAREH
A-G06	OFFICE	34.6 m <sup>2</sup>	A-G13	OFFICE	37.0 m <sup>2</sup>	B-G01	OFFICE	53.1 m²	B-G08	OFFICE
		142.2 m <sup>2</sup>			155.2 m²			256.4 m <sup>2</sup>		
A-G07			A-G14			B-G02			B-G09	
A-G07	INDUSTRIAL	78.2 m <sup>2</sup>	A-G14	WAREHOUSE	117.9 m <sup>2</sup>	B-G02	WAREHOUSE	203.6 m <sup>2</sup>	B-G09	WAREH
A-G07	OFFICE	31.9 m <sup>2</sup>	A-G14	OFFICE	46.8 m <sup>2</sup>	B-G02	OFFICE	53.5 m²	B-G09	OFFICE
		110.1 m <sup>2</sup>			164.6 m <sup>2</sup>			257.1 m <sup>2</sup>		

# LEVEL 1 UNITS SCHEDULE

UNIT NUMBER	UNIT TYPE	AREA	UNIT NUMBER	UNIT TYPE	AREA	UNIT NUMBER	UNIT TYPE	AF
						D 400		
A-101	055105	04.0	A-111		70 7 2	B-103	055105	07.0
A-101	OFFICE INDUSTRIAL	24.2 m <sup>2</sup> 88.8 m <sup>2</sup>	A-111	INDUSTRIAL OFFICE	70.7 m² 18.7 m²	B-103	OFFICE	27.2
A-101	INDUSTRIAL	113.0 m <sup>2</sup>	A-111	OFFICE	89.4 m <sup>2</sup>	B-103	INDUSTRIAL	83.3
		113.0 11			09.4 111			110.5
A-102			A-112			B-104		
A-102	OFFICE	24.2 m <sup>2</sup>	A-112	OFFICE	37.0 m <sup>2</sup>	B-104	OFFICE	27.2
A-102	INDUSTRIAL	88.8 m <sup>2</sup>	A-112	INDUSTRIAL	118.2 m <sup>2</sup>	B-104	INDUSTRIAL	96.2
		113.0 m <sup>2</sup>			155.2 m <sup>2</sup>			123.4
4-103			A-113			B-105		
A-103	OFFICE	24.2 m <sup>2</sup>	A-113	OFFICE	46.7 m <sup>2</sup>	B-105	INDUSTRIAL	74.7
A-103	INDUSTRIAL	88.8 m <sup>2</sup>	A-113	WAREHOUSE	117.9 m <sup>2</sup>	B-105	OFFICE	22.2
		113.0 m <sup>2</sup>			164.6 m <sup>2</sup>			96.9
A-104			A-114			B-106		
A-104	OFFICE	24.2 m <sup>2</sup>	A-114	OFFICE	46.7 m <sup>2</sup>	B-106	INDUSTRIAL	74.1
<b>\-104</b>	INDUSTRIAL	88.8 m <sup>2</sup>	A-114	WAREHOUSE	117.9 m <sup>2</sup>	B-106	OFFICE	29.4
		113.0 m <sup>2</sup>			164.6 m <sup>2</sup>			103.5
<b>\-105</b>			A-115			B-107		
-105	OFFICE	24.2 m <sup>2</sup>	A-115	OFFICE	46.8 m <sup>2</sup>	B-107	OFFICE	28.6
A-105	INDUSTRIAL	88.8 m <sup>2</sup>	A-115	WAREHOUSE	117.9 m <sup>2</sup>	B-107	INDUSTRIAL	114.1
		113.0 m <sup>2</sup>			164.7 m <sup>2</sup>			142.7
A-106		00.0	A-116	055105	10.0	B-108	055105	07.0
A-106	INDUSTRIAL	88.8 m <sup>2</sup>	A-116	OFFICE	46.8 m <sup>2</sup>	B-108	OFFICE	27.2
A-106	OFFICE	34.5 m <sup>2</sup>	A-116	WAREHOUSE	117.9 m <sup>2</sup>	B-108	INDUSTRIAL	114.1
		123.3 m²			164.7 m²			141.2
<b>\-107</b>			A-117			B-109		
A-107	INDUSTRIAL	101.1 m <sup>2</sup>	A-117	OFFICE	46.9 m <sup>2</sup>	B-109	OFFICE	28.4
A-107	OFFICE	29.2 m <sup>2</sup>	A-117	WAREHOUSE	117.9 m <sup>2</sup>	B-109	INDUSTRIAL	114.1
		130.3 m <sup>2</sup>			164.7 m <sup>2</sup>			142.4
A-108			A-118			B-110		
A-108	INDUSTRIAL	88.8 m <sup>2</sup>	A-118	OFFICE	46.8 m <sup>2</sup>	B-110	OFFICE	42.7
A-108	OFFICE	33.0 m <sup>2</sup>	A-118	WAREHOUSE	117.9 m <sup>2</sup>	B-110	WAREHOUSE	180.5
		121.8 m <sup>2</sup>			164.7 m <sup>2</sup>	<u> </u>		223.2
			B-101	1 1		B-111		
		88.8 m <sup>2</sup>	B-101	OFFICE	15.7 m <sup>2</sup>	B-111	OFFICE	42.2
<b>\-109</b>	INDUSTRIAL			UNID LIG TRUM	57.5 m²	B-111	INDUSTRIAL	104.9
A-109	INDUSTRIAL OFFICE	33.0 m <sup>2</sup>	B-101	INDUSTRIAL		D-TTT	11000110712	
4-109			B-101	INDUSTRIAL	73.2 m <sup>2</sup>			147.1
A-109 A-109		33.0 m <sup>2</sup>		INDUSTRIAL				147.1
A-109 A-109 A-110		33.0 m <sup>2</sup>	B-101 B-102 B-102	OFFICE		B-112 B-112		
A-109 A-109 A-109 A-110 A-110 A-110 A-110	OFFICE	33.0 m <sup>2</sup> 121.8 m <sup>2</sup>	B-102		73.2 m²	B-112	OFFICE	147.1 42.2 104.9

# **DEVELOPMENT APPLICATION**

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Plans - PPSSSH-104 (17 May 2022) - DA21/1131

2	UNIT TYPE	AREA
	WAREHOUSE	203.3 m <sup>2</sup>
	OFFICE	53.6 m <sup>2</sup>
		256.8 m <sup>2</sup>
	WAREHOUSE	175.7 m²
	OFFICE	40.3 m <sup>2</sup>
		216.0 m <sup>2</sup>
	WAREHOUSE	179.8 m²
	OFFICE	56.7 m²
		236.5 m <sup>2</sup>
	WAREHOUSE	177.5 m <sup>2</sup>
	OFFICE	56.5 m <sup>2</sup>
		234.1 m²
	OFFICE	56.1 m²
	WAREHOUSE	171.0 m <sup>2</sup>
		227.0 m <sup>2</sup>
	WAREHOUSE	245.6 m <sup>2</sup>
	OFFICE	68.5 m²
		314.0 m <sup>2</sup>
	WAREHOUSE	225.3 m <sup>2</sup>
	OFFICE	68.1 m²
		293.5 m²

UNIT NUMBER	UNIT TYPE	AREA
B-G10		
B-G10	WAREHOUSE	197.1 m <sup>2</sup>
B-G10	OFFICE	60.0 m <sup>2</sup>
		257.1 m <sup>2</sup>
B-G11		
B-G11	WAREHOUSE	168.8 m <sup>2</sup>
B-G11	OFFICE	60.3 m <sup>2</sup>
		229.1 m <sup>2</sup>
B-G12		
B-G12	WAREHOUSE	140.9 m <sup>2</sup>
B-G12	OFFICE	42.4 m <sup>2</sup>
		183.3 m <sup>2</sup>
B-G13		
B-G13	INDUSTRIAL	112.6 m <sup>2</sup>
0.0	OFFICE	42.7 m <sup>2</sup>
B-G13	OTTIOL	

UNIT NUMBER	UNIT TYPE	AREA	UNIT NUMBER	UNIT TYPE	AREA
B-113			B-123		
B-113	OFFICE	42.2 m <sup>2</sup>	B-123	OFFICE	42.8 m <sup>2</sup>
B-113	INDUSTRIAL	104.9 m <sup>2</sup>	B-123	WAREHOUSE	120.2 m <sup>2</sup>
	11200114742	147.1 m <sup>2</sup>		TH THE HOUSE	163.0 m <sup>2</sup>
B-114					
B-114	OFFICE	42.2 m <sup>2</sup>			
B-114	INDUSTRIAL	104.9 m <sup>2</sup>			
		147.1 m <sup>2</sup>			
B-115					
B-115	OFFICE	42.8 m <sup>2</sup>			
B-115	WAREHOUSE	120.2 m <sup>2</sup>			
		163.0 m <sup>2</sup>			
B-116					
B-116	OFFICE	33.3 m <sup>2</sup>			
B-116	INDUSTRIAL	96.0 m²			
		129.2 m <sup>2</sup>			
B-117					
B-117	INDUSTRIAL	91.2 m <sup>2</sup>			
B-117	OFFICE	33.3 m <sup>2</sup>			
		124.5 m <sup>2</sup>			
B-118					
B-118	INDUSTRIAL	81.7 m <sup>2</sup>			
B-118	OFFICE	32.3 m²			
		114.0 m <sup>2</sup>			
B-119					
B-119	INDUSTRIAL	96.0 m <sup>2</sup>			
B-119	OFFICE	33.3 m <sup>2</sup>			
		129.2 m <sup>2</sup>			
B-120					
B-120	OFFICE	33.3 m <sup>2</sup>			
B-120	INDUSTRIAL	96.0 m <sup>2</sup> 129.2 m <sup>2</sup>			
		123.2 111			
B-121					
B-121	OFFICE	33.3 m <sup>2</sup>			
B-121	INDUSTRIAL	96.0 m <sup>2</sup>			
		129.2 m <sup>2</sup>			
B-122					
B-122	OFFICE	33.3 m <sup>2</sup>			
B-122	INDUSTRIAL	96.0 m <sup>2</sup>			
B-122	INDUSTRIAL	96.0 m <sup>2</sup> 129.2 m <sup>2</sup>			

# UNITS WITH MRV ACCESS

ALL UNITS HAVE SRV ACCESS AT MINIMUM

Unit Number	MRV Access
B-G01	Yes
B-G02	Yes
B-G03	Yes
B-G05	Yes
B-G06	Yes
B-G13	Yes

## LEVEL 2 UNITS SCHEDULE

UNIT NUMBER	UNIT TYPE	AREA	UNIT NUME
A-201			A-211
A-201	INDUSTRIAL	88.8 m²	A-211
A-201	OFFICE	24.5 m <sup>2</sup>	A-211
A-201	OFFICE	113.3 m <sup>2</sup>	A-211
A-202			A-212
A-202	INDUSTRIAL	88.8 m <sup>2</sup>	A-212
A-202	OFFICE	24.5 m <sup>2</sup>	A-212
	0	113.3 m <sup>2</sup>	
A-203			A-213
A-203	INDUSTRIAL	88.8 m <sup>2</sup>	A-213
A-203	OFFICE	24.5 m <sup>2</sup>	A-213
		113.3 m²	
A-204			A-214
A-204	INDUSTRIAL	88.8 m <sup>2</sup>	A-214
A-204	OFFICE	24.5 m <sup>2</sup>	A-214
		113.3 m <sup>2</sup>	L.
A-205			A-215
A-205	INDUSTRIAL	88.8 m <sup>2</sup>	A-215
A-205	OFFICE	24.5 m <sup>2</sup>	A-215
		113.3 m <sup>2</sup>	
A-206			A-216
A-206	INDUSTRIAL	88.8 m²	A-216
A-206 A-206	OFFICE	24.5 m <sup>2</sup>	A-216
A-200	OFFICE	24.5 m <sup>2</sup>	A-210
		110.0 m	
A-207			A-217
A-207	INDUSTRIAL	114.5 m <sup>2</sup>	A-217
A-207	OFFICE	24.5 m <sup>2</sup>	A-217
		139.1 m²	
A-208			A-218
A-208	INDUSTRIAL	101.1 m <sup>2</sup>	A-218
A-208	OFFICE	29.7 m <sup>2</sup>	A-218
		130.7 m <sup>2</sup>	
A-209			A-219
A-209	INDUSTRIAL	89.2 m <sup>2</sup>	A-219
A-209	OFFICE	21.7 m <sup>2</sup>	A-219
	1	110.9 m <sup>2</sup>	
A 210			D 201
A-210 A-210		80.2 m <sup>2</sup>	B-201 B-201
A-210 A-210	INDUSTRIAL OFFICE	89.2 m <sup>2</sup> 21.7 m <sup>2</sup>	
A-210	UFFICE	21.7 m <sup>2</sup>	B-201
		110.9 m²	

INIT NUMBER	UNIT TYPE	AREA
211		
211	INDUSTRIAL	89.2 m <sup>2</sup>
211	OFFICE	21.7 m <sup>2</sup>
		110.9 m <sup>2</sup>
212		
212	INDUSTRIAL	70.7 m <sup>2</sup>
212	OFFICE	21.7 m <sup>2</sup>
		92.4 m²
213		
213	INDUSTRIAL	108.9 m <sup>2</sup>
213	OFFICE	16.2 m <sup>2</sup>
		125.0 m <sup>2</sup>
214		
214 214	WAREHOUSE	108.2 m <sup>2</sup>
214	OFFICE	42.5 m <sup>2</sup>
<u> </u>		150.6 m <sup>2</sup>
		100.0 11
215	WARELIOUSE	109.0 2
215	WAREHOUSE	108.2 m <sup>2</sup>
215	OFFICE	42.5 m <sup>2</sup> 150.6 m <sup>2</sup>
		150.0 11
216		
216	WAREHOUSE	117.9 m <sup>2</sup>
216	OFFICE	46.8 m <sup>2</sup>
	I	164.7 m <sup>2</sup>
217		447.0 2
217 217	WAREHOUSE OFFICE	117.9 m <sup>2</sup>
21/	OFFICE	46.8 m <sup>2</sup>
		104./ 111-
218		
218	WAREHOUSE	117.9 m <sup>2</sup>
218	OFFICE	46.9 m <sup>2</sup>
		164.7 m²
219		
219	WAREHOUSE	117.9 m <sup>2</sup>
219	OFFICE	46.8 m <sup>2</sup>
		164.7 m²
201		
201	OFFICE	15.9 m²
201	INDUSTRIAL	57.5 m²
	I	73.4 m <sup>2</sup>

B-204 B-204 B-204 B-205 B-205 B-205 B-206 B-206 B-206 B-207 B-207 B-207 B-208 B-208 B-208 B-209 B-209 B-209 B-210 B-210 B-210 B-211 B-211 B-211

UNIT NUMBEI

B-202 B-202 B-202

B-203

B-203 B-203

Project Taren Point

Drawing Development Summary 221038 04.04.22

Author Scale: @ A1

72-78 Box Road, Taren Point

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R	UNIT TYPE	AREA
	OFFICE	25.2 m <sup>2</sup>
	INDUSTRIAL	70.4 m <sup>2</sup>
	INDUSTRIAL	95.5 m <sup>2</sup>
		99.9 m
	INDUSTRIAL	83.3 m²
	OFFICE	27.2 m <sup>2</sup>
		110.5 m <sup>2</sup>
	INDUSTRIAL	96.2 m <sup>2</sup>
	OFFICE	27.2 m <sup>2</sup>
		123.4 m <sup>2</sup>
	OFFICE	31.1 m <sup>2</sup>
	INDUSTRIAL	127.7 m <sup>2</sup>
		158.8 m²
	OFFICE	32.7 m <sup>2</sup>
	WAREHOUSE	133.9 m <sup>2</sup>
		166.5 m²
	OFFICE	35.3 m²
	WAREHOUSE	150.6 m <sup>2</sup>
		185.9 m²
	OFFICE	28.6 m <sup>2</sup>
	INDUSTRIAL	114.1 m <sup>2</sup>
		142.7 m²
	OFFICE	27.2 m <sup>2</sup>
	INDUSTRIAL	114.1 m <sup>2</sup>
		141.2 m <sup>2</sup>
	OFFICE	28.4 m²
	INDUSTRIAL	113.7 m <sup>2</sup>
		142.1 m <sup>2</sup>
	OFFICE	42.7 m <sup>2</sup>
	WAREHOUSE	180.1 m <sup>2</sup>
		222.8 m <sup>2</sup>

Drawing No. TP05.03 A

UNIT NUMBER	UNIT TYPE	AREA
B-212		105.0
B-212	INDUSTRIAL	105.2 m <sup>2</sup>
3-212	OFFICE	36.2 m <sup>2</sup>
		141.4 m²
3-213		
B-213	INDUSTRIAL	105.2 m <sup>2</sup>
B-213	OFFICE	36.2 m²
		141.4 m <sup>2</sup>
3-214		
B-214	INDUSTRIAL	105.2 m <sup>2</sup>
3-214	OFFICE	36.2 m²
		141.4 m²
B-215		
B-215	INDUSTRIAL	105.2 m <sup>2</sup>
B-215	OFFICE	36.2 m <sup>2</sup>
		141.4 m <sup>2</sup>
3-216		
B-216	WAREHOUSE	120.2 m <sup>2</sup>
3-216	OFFICE	46.3 m <sup>2</sup>
		166.5 m <sup>2</sup>
B-217		
3-217	WAREHOUSE	120.2 m <sup>2</sup>
3-217	OFFICE	46.3 m <sup>2</sup>
		166.5 m <sup>2</sup>
3-218		
B-218	INDUSTRIAL	111.9 m <sup>2</sup>
3-218	OFFICE	46.3 m <sup>2</sup>
		158.2 m <sup>2</sup>
B-219		
3-219	INDUSTRIAL	102.3 m <sup>2</sup>
3-219	OFFICE	46.3 m <sup>2</sup>
	I	148.6 m <sup>2</sup>
3-220		
B-220	WAREHOUSE	120.2 m <sup>2</sup>
3-220	OFFICE	46.3 m <sup>2</sup>
		166.5 m <sup>2</sup>
3-221		
B-221	WAREHOUSE	120.2 m <sup>2</sup>
	OFFICE	46.3 m <sup>2</sup>
B-221		

UNIT NUMBER	UNIT TYPE	AREA
B-222		
B-222	WAREHOUSE	120.2 m <sup>2</sup>
B-222	OFFICE	46.3 m <sup>2</sup>
		166.5 m <sup>2</sup>
B-223		
B-223	WAREHOUSE	120.2 m <sup>2</sup>
B-223	OFFICE	46.3 m <sup>2</sup>
		166.5 m <sup>2</sup>
B-224		
B-224	OFFICE	46.3 m <sup>2</sup>
B-224	WAREHOUSE	120.2 m <sup>2</sup>
		166.5 m <sup>2</sup>






Plans - PPSSSH-104 (17 May 2022) - DA21/1131

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Planting symbol (See schedule, sheet 4)


Plans - PPSSSH-104 (17 May 2022) - DA21/1131



Ам	ENDMENTS		
	4.4.2022		
C	30.9.2021		
В	30.9.21		
Α	18.9.21	-	

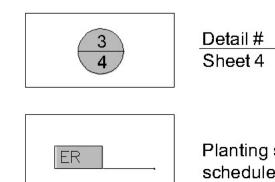


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Project:	Project: New development			
	72-78	8 Box	Road,	
	TARE	N POI	NT, NSW	
Dwg:	LAND	SCAPE	PLAN -	LEVEL 1

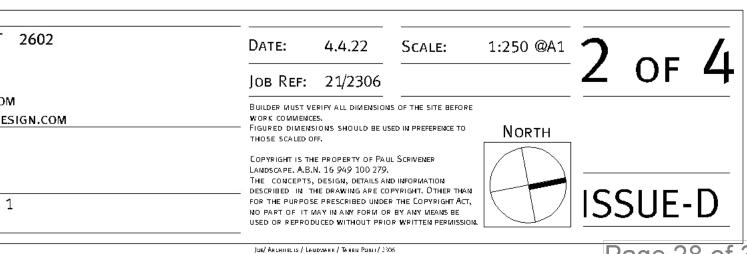

10





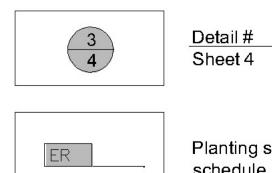

Planting symbol (See schedule, sheet 4)

Plans - PPSSSH-104 (17 May 2022) - DA21/1131

MENDMENTS	\.	PO Box 4050. ACT 2602 ABN: 16 949 100 279	DATE: 4.4.22 SCALE: 1:250 @A1	
4.4.2022         30.9.2021         30.9.21         18.9.21	PAULSCRIVENER	Phone: 02 9907 8011 www.scrivener-design.com Email: paul@scrivener-design.com Project: New development 72-78 Box Road, Taren Point, NSW Dwg: Landscape Plan - Level 2	JOB REF: 21/2306 Builder Must Verify All Dimensions of the site before work commences. Figured Dimensions should be used in preference to those scaled off. Copyright is the property of Paul Scrivener Landscape, A.B.N. 16 949 100 279. The concepts, design, details and information described in the drawing are copyright. Other than for the purpose prescribed under the Copyright Act, no part of it may in any form or by any means be used or reproduced without prior written permission.	SUE-D

## Planting schedule

Tree species and most understory species generally selected from Sutherland Shire Council Environmental Specification: Locality guidelines Taren Point Road and Taren Point Employment Area locality

Symbol	Botanical name	Common name	Cont.	Staking	Mature	No
			size		height	req.
Trees						
ALT	Alcasuarina littoralis	Black She-Oak (Tall narrow hardy screen tree)	75Lt	3x50x50x1800	10-13.0M	7
ANO	Angophora costata	Sydney Red Gum (large native tree. Striking bark colour)	45Lt	3x50x50x1800	16-25.0M	1
ASM	Acmena smithii	Lilly Pilly (Native tree in dep soil. Prune lower branches)	75Lt	3x50x50x1800	8-10.0M	1
BIN	Banksia integrifolia	Coast Banksia (hardy native tree common in local area)	200Lt	3x50x50x1800	15-18.0M	3
CAG	Casuarina glauca	Swamp Oak (med native tree vertical habit)	45Lt	3x50x50x1800	12-15.0M	5
BAS	Bankisa serrrata	Old Man Banksia(medium indigenous tree)	45Lt	3x50x50x1800	12-15.0M	1
ER	Elaeocarpus reticulatus	Blueberry Ash (indigenous small tree)	300mm	2x50x50x1800	6-8.0M	3
MLQ	Melalueca quinquenervia	Flax Leaf Paperbark (Native street tree to supplement existing)	75Lt	4x50x50x1800	12-15.0M	6
TLL	Tristaniopsis laurina 'Luscious'	Water Gum cultivar (indigenous small-med tree)	75Lt	3x50x50x1800	5-7.0M	1
	/ small feature trees					
CVE	Callistemon citrinus 'Endeavor'	Endeavor Crismson Bottlebrush (Flowering native small tree)		nil	3-4.0M	8
SYR	Syzygium 'Resilience'	Resilience Lilly Pilly (native screen plant. Can be hedged)	300mm	hedged	2.8-3.5M	4
WF	Westringia fruticosa	Coastal Rosemary (native shrub. Can be informally hedged))	300mm	hedged	1.5-2.0M	6
	Palms / Succulents / ornamenta					
CAA	Cyathea australe	Tree Fern (Native tree ferns)	200mm	nil	2-4.0M	12
DOE	Doryanthese excelsor	Gymea Lilly (striking palm like). Tall red flower on spike)	300mm	nil	1.5-2.0M	2
LAV	Livistona australis	Cabbage Palm (tall indigenous palm)	semi adv	wire guys	8-12.0M	3
RHA	Raphis excelsor	Lady Finger Palm	300mm	nil	2-2.5M	24
	covers/Climbers					• /
CIS	Cissus antarctica	Kangaroo Vine (Hardy native climber n vertical cables	300mm	Vertical cables	0.3M	64
CLA	Clematis aristata	Old Mans Beard (native flowering climber / groundcover)	200mm	wire supports on fence	0.3M	20
CRG	Carpobrotus glaucescens	<b>Pigface</b> (very hardy salt wind tolerant trailing groundcover)	140mm	nil	0.2M	32
VH	Viola hederacea	Native Violets (native low groundcover)	tubes	nil	0.1M	100
	ntal grasses/strappy leaved pla					
DIC	Dianella caerulea	Blue Flax Lily (blue foliage native grass like plant)	100mm	nil	0.4M	170
LIM	Liriope Evergreen Giant	Turf Lily (shade tolerant groundcover)	150mm	nil	0.4M	60
LOT	Lomandra 'Tanika'	Dwarf Mat Rush (native mass planted groundcover)	140mm	nil	0.4M	40
LOM	Lomandra longifolia	Spiny Mat Rush (Tall hardy grass like clumping plant)	200mm	nil	1-1.2M	35

Planting schedule species to be sourced from local nurseries supplying plants of local provenance wherever possible. Landscape contractor is to check plant numbers on plan against the schedule prior to submitting tender price. Contact landscape architect if any number discrepancies are found. Council compliance controls require that any substitution of species variety or container size MUST be confirmed with landscape architect to ensure a compliance certificate can be issued that's meets the specific development consent conditions of the project.

### Proposed plant species assemblage to supplement the Swamp Oak trees located in the south western corner surrounding the existing tidally influenced drainage channel

In addition to the supplemental proposed Casuarina glauca (swamp oaks) nominated on sheet 1 additional plantings are to include selected species including "... Alternanthera denticulata (lesser joyweed), Baumea juncea (bare twig rush), Cynodon dactylon (sand couch), Juncus kraussii subsp. australiensis (sea rush), Phragmites australis (common reed), Samolus repens (creeping brook or bushweed), Selliera radicans (swamp weed), and Suaeda australis (austral seablite)..'

Source: <u>http://www.environment.gov.au/biodiversity/threatened/communities/pubs/141-conservation-advice</u> Environment Protection and Biodiversity Conservation Act 1999 (EPBC Act) (s266B) Conservation advice (incorporating listing advice) for the Coastal Swamp Oak (Casuarina glauca) Forest of New South Wales and South East Queensland ecological community. Section 2.3.3

### General installation notes

### **1.Site preparation**

Any existing trees and vegetation to be retained shall be preserved and protected from damage of any sort during the execution of landscape work. In particular, root systems of existing plants must not be disturbed if possible. Any nearby site works should be carried carefully using hand tools. To ensure the survival and growth of existing trees during landscaping works, protect by fencing or armoring where necessary. Trees shall not be removed or lopped unless specific written approval to do so is given or is indicated on plan. Storage of materials, mixing of materials, vehicle parking, disposal of liquids, machinery repairs and refueling, site office and sheds, and the lighting of fires shall not occur within three (3) metres of any existing trees. Do not stockpile soil, rubble or other debris cleared from the site, or building materials, within the dripline of existing trees. Vehicular access shall not be permitted within three (3) metres of any tree.

### 2. Soil preparation

All proposed planting areas to be deep ripped to 200mm (where possible) and clay soils to be treated with clay breaker. Apply at least 200mm depth good quality garden soil mix to all garden planting areas. To comply with AS 4419 Turfed areas as noted to be laid over 100mm min. good quality turf underlay over existing soil which is to be deep ripped to 200mm depth prior to installation. To be worked in with rotary hoe except where tree root damage would otherwise occur. In such situations care to be taken to hand cultivate in any area where existing tree roots exist to preserve health of trees and to comply with the requirements of the Arborist's report. Where planting is to occur in existing soil profiles ensure soil conditioners and compost worked into the top 200mm profile. To comply with AS 4454:1999.

### 3. New plantings

Newly planted trees and large shrubs should be secured to stakes with hessian ties to prevent rocking by wind. Planting holes for plant material should be large enough in size to take root ball with additional space to take back filling of good quality planting mix. (Please note mature heights of planting as shown on planting schedule can vary due to site conditions, locations in constricted deep soil or over slab planters and so forth) Also shallow soils in certain locations may affect planting heights. Nominated heights for plantings in raised planters over slabs are nominated as less than their normal expected heights in acknowledgement of the contained soil environment. For other deep soil trees heights are subject to particular site conditions, and intended hedging or pruning for functional requirements such as available planting width, intended access under branches and solar access.

### 4. Planter wall waterproofing.

All slab areas to be waterproofed and 'Atlantis' drainage cell installed with geotextile fabric or similar approved. Refer Engineer's details for ALL structural, drainage and installation details whatsoever for wall construction. All raised gardlens to have the following soils: • Benedicts Smart Mix no. 4 Lightweight Planter Mix (or approved equivalent) to min. 400-500mm depth.. To comply with AS 4419 and AS 3743

All planter boxes are to have automatic dripline irrigation system.

• Landscape contractor to install all planter box fill material and plant material after other site works are completed to ensure no deterioration of waterproof membrane behind external walls.

### 5. Mulchina

All planting areas to be mulched with a minimum 75mm thick cover of recycled hard wood chip mulch and then all plant areas to be thoroughly soaked with water. To comply with AS 4454

### 6. Fertliser

All planting areas to be fertilised with 9 month 'NPK' slow release fertiliser.

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### 7. Staking

To those plants indicated on the planting schedules provide: hardwood stakes as nominated and driven into ground to a depth able to achieve rigid support. No staking in raisec planters to avoid damaging waterproofing installation

### 8. Turfing

Turfed areas to be to be laid over 100mm good quality turf underlay over existing soil which is to be deep ripped to 200mm depth prior to installation. See details sheet

### 9. Structural

All structural details whatsoever to Engineer's details.

supply tap hosecocks and water supply conduit to be dinated by Hydraulic and Structural Engineer's details). Dripline ly system only to be incorporated.

ractor responsible for the irrigation installation is to provide an tion design to meet the following requirementts. erally: Supply an automatic drip line irrigation system. To de all piping to solenoids either PVC lines and/or class 12 sure pipe or low density, rubber modified polypropeyline Ilation as required to provide water supply to the nominated . To be coordinated with Hydraulic engineers plans. To include ends, junctions, ends, ball valves, solenoids and all other lary equipment. Backwash valve: An approved backwash ention valve is to be located at the primary water source for top alves to rainwater tanks (where applicable).

matic Controller: For all common area landscape areas provide natic 2 week timer with hourly multi-cycle operation for each as noted on the irrigation areas plan on sheet. Battery timers to ted planter boxes to private terraces.

rmance: It shall be the Landscape Contractor's responsibility to re and guarantee satisfactory operation of the irrigation system. system is to be fit for the purpose and should utilize sufficient noids to provide for the varying watering requirements of cape areas to allow all plants and lawn areas to thrive and long term viability.

Testing: After the system has been installed to the satisfaction of the project manager, the installation shall be tested under working conditions. Acceptance of the installed plant and equipment shall be subject to these being satisfactory.

Warranty: A twelve month warranty is to be provided in writing by the Landscape Contractor, which shall commit the Landscape Contractor to rectify the system (the items they have installed) to the satisfaction of the project manager or nominated representative This will apply should any fault develop, or the capacity or efficiency fall below that guaranteed, or should the discharge or pressure be inadequate, or should defects develop in the filter unit or control heads, or any blockages that nay develop in the system.

Approvals: The Landscape Contractor is to liaise as necessary, to ensure that the irrigation system conforms with all Water Board, Council and Australian standards (AS)

## Maintenance schedule

The Landscape Contractor shall maintain the contract areas by accepted horticultural practices as well as rectifying any defects that become apparent in the works under normal use. The Landscape Contractor shall maintain the works and make good all defects for a period of twenty six (26) weeks after the date of practical completion. Practical completion of the landscape works shall include but not be limited to the replacement of plants which have failed or been damaged or stolen during work under the contract. Landscape maintenance shall include but not be limited to the following: watering, rubbish removal, spraying and wiping leaf surfaces, replacing failed plants, maintaining mulch, pruning, insect and disease control, cleaning of surrounding areas. Mow the nature strip turf when it is established at regular intervals to maintain an average height of 50mm.

maintenance shall include the following:

- coverage in all garden beds
- applications
- required
- discovered

### Irrigation notes

Automatic drip line watering system to be selected. To extend to ALL raised planters over slab areas only as noted on individual

to approval by the project manager and prior to installation the

ure rain sesnsor is installed for common area garden zones ected to automatic timer system.

inhibiting system. Driplines to be 'Netafim Techline AS XR' drip g or approved equivalent

### After the completion of the defects period noted above the owners of the development are responsible for the ongoing maintenance and viability of the gardens and ongoing

 Regular hand watering of gardens if installed drip line irrigation system is turned off. Irrigation to be installed and maintained as per manufacturers specifications including regular checks for function of system, to check for leaks and to ensure general good working operation. Regular maintenance of the irrigation system battery timers (where required) for isolated planter beds in common areas. Battery timers for private terraces are the responsibility of the individual unit owners. Mulch is to be regularly topped up every 6 months to ensure an even 75mm


 Regular pruning of plants is to be undertaken to ensure continued uniform growth of canopy and foliage of trees and shrubs. Removal of vegetation over the long term (if and when required) as the garden matures. Subject to the relevant council


 Regular assessment of plants for evidence of insect attack or disease. Appropriate pest oil, white oil of industry standard safe to use pest spray is to be employed if


• Garden/lawn edging to be inspected regularly after practical completion to ensure it is maintained in good order. Replace where required if defective sections are


• All garden refuse, rubbish and associated items that arise from the regular garden maintenance procedures are to be collected and stored in appropriate general waste or green waste containers as is appropriate. Excess waste unable to be stored in Council waste containers is o be removed from the site is a timely manner.

## Proposed planting palette

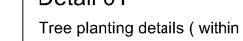


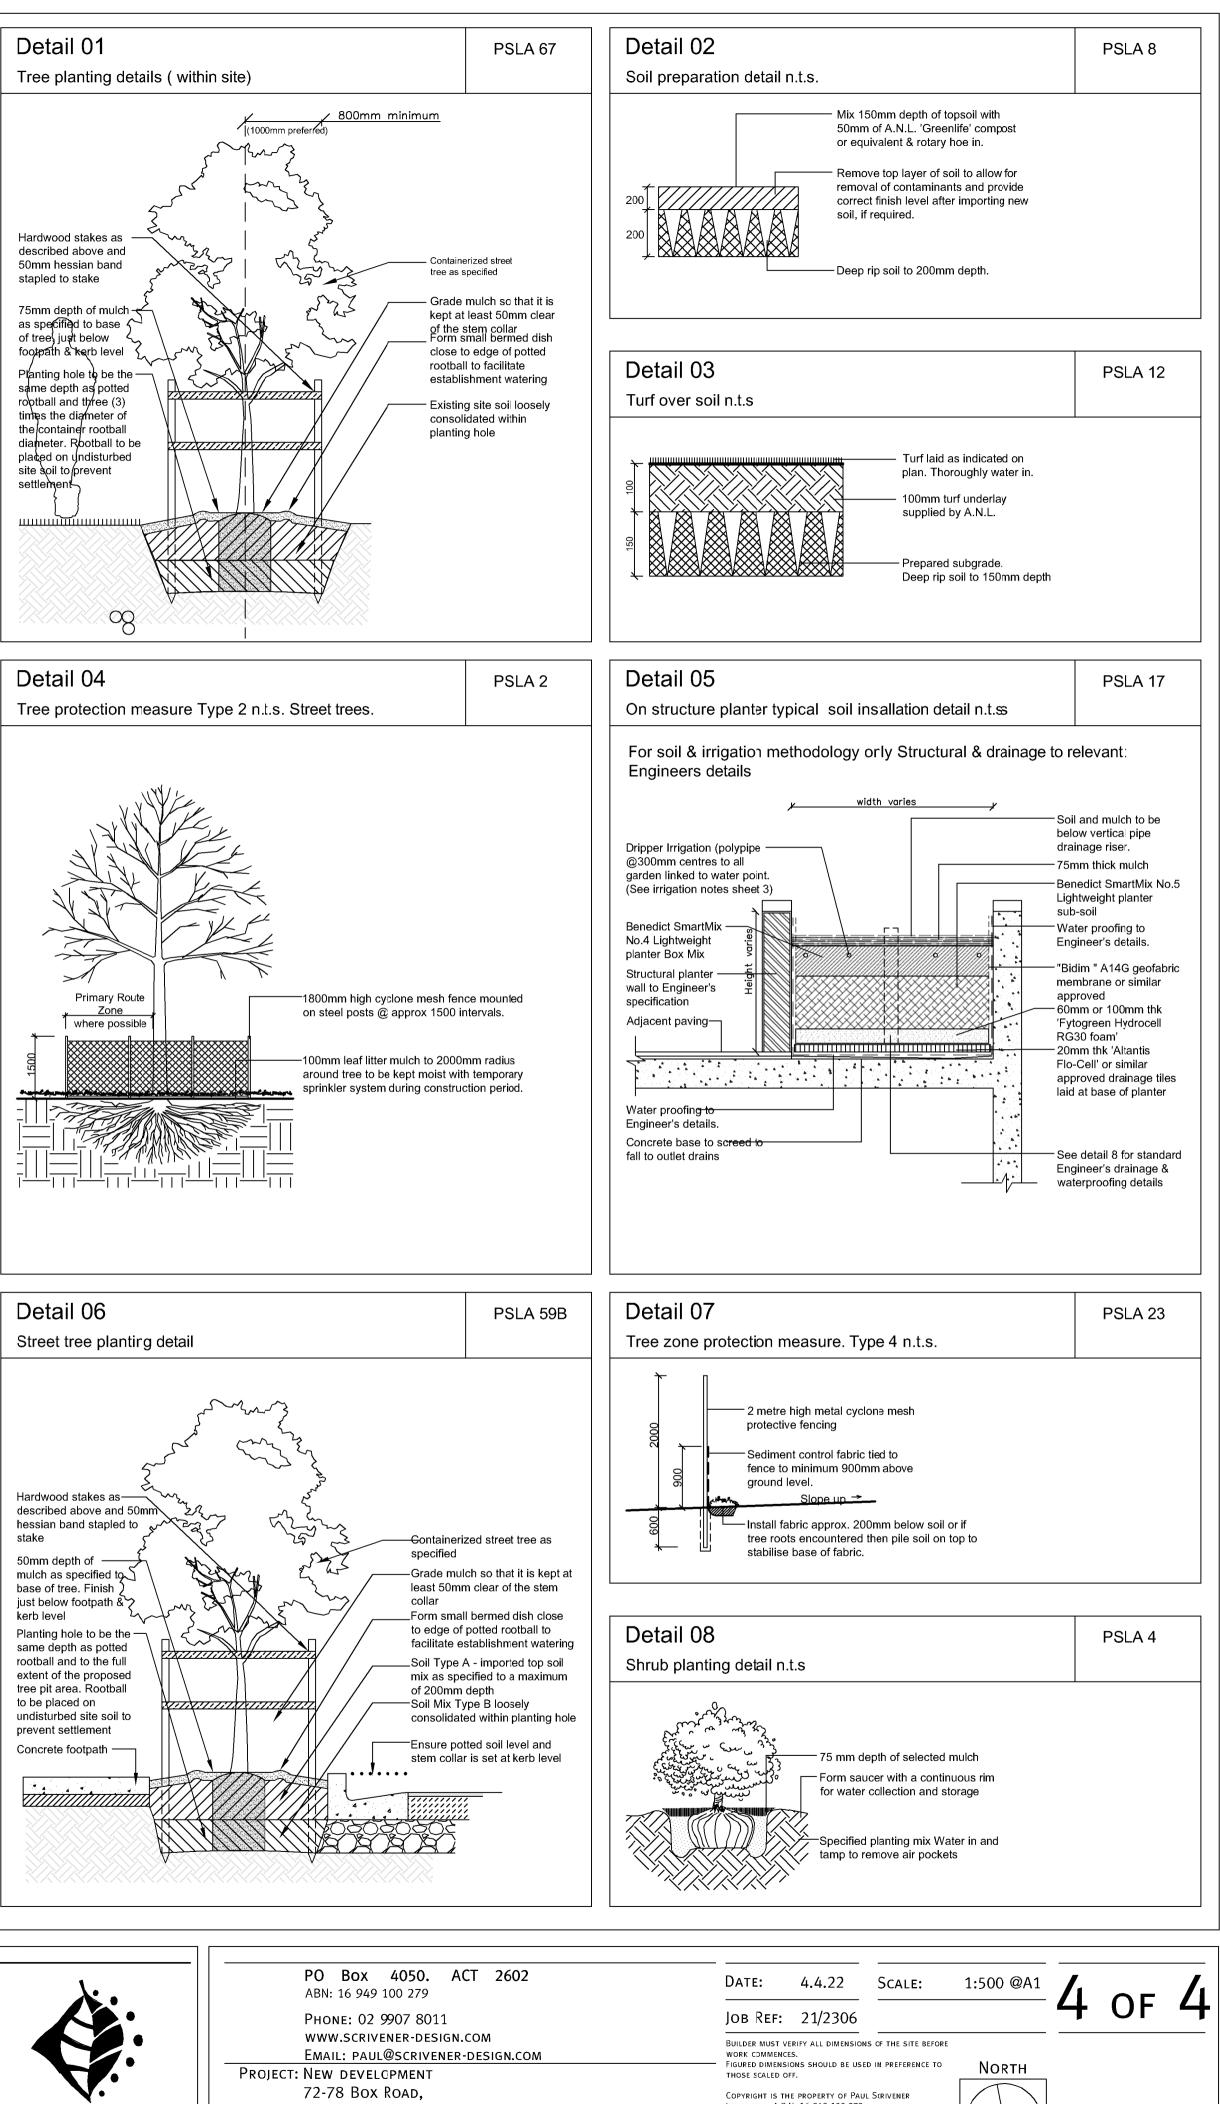

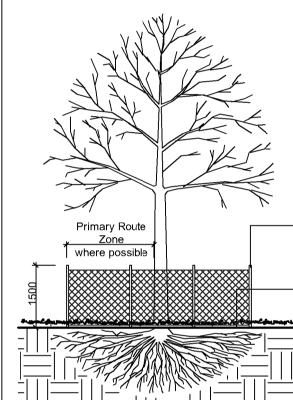

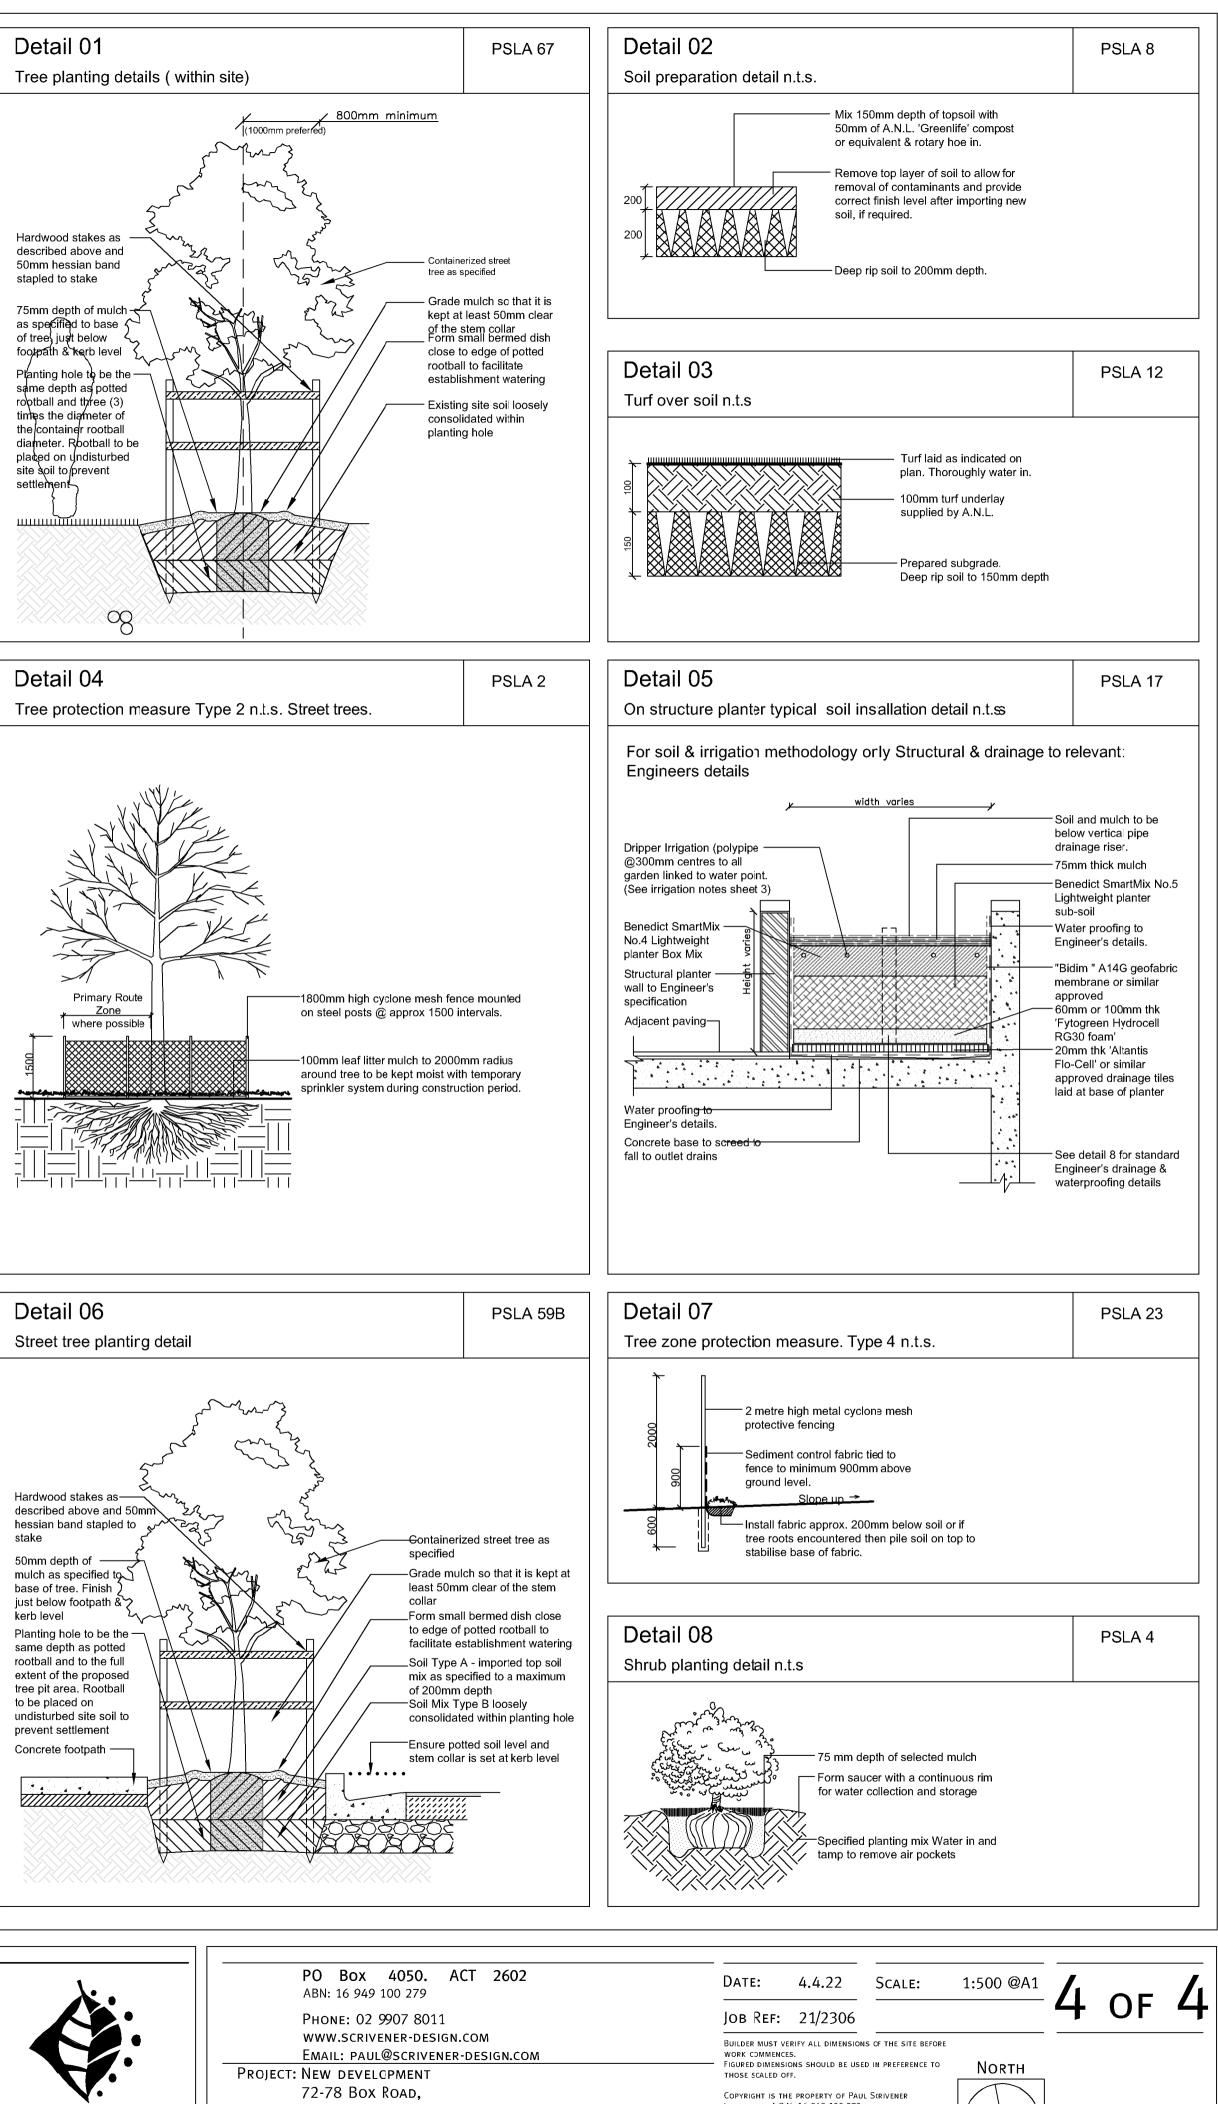

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	Phone: 02 9907 8011 www.scrivener-design.com Email: paul@scrivener-design.com
	Project: New development 72-78 Box Road, Taren Point, NSW
 PAUL SCRIVENER LANDSCAPE	Dwg: Landscape Plan - Notes & Details

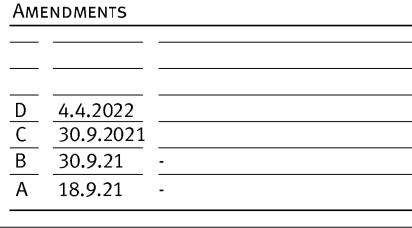

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